

| GENERAL NOTES | |
|---|--|
| 1.0. TOPOGRAPHIC AND PROPERTY LINE INFORMATION | |
| 1.1. NOTICE TO CONTRACTOR: THE CONTRACTOR IS SPECIFICALLY CAUTIONED THAT THE LOCATION AND/OR ELEVATION OF EXISTING UTILITIES AND STRUCTURES AS SHOWN ON THESE PLANS BASED ON RECORDS OF VARIOUS UTILITIES COMPANIES WHERE POSSIBLE, BE RELIED ON AS BEING EXACT OR COMPLETE. THE LOCATION OF ALL UNDERGROUND UTILITIES AND STRUCTURES SHALL BE DETERMINED BY THE FIELD BY THE CONTRACTOR. THE STATE OF THE FIELD BY THE CONTRACTOR MUST CONTACT THE APPROPRIATE UTILITY COMPANY, ANY GOVERNING PERMITTING AUTHORITY, AND "DISSAFE" AT LEAST 72 HOURS PRIOR TO THE COMMENCEMENT OF WORK TO REQUEST INFORMATION ON THE LOCATION OF UTILITIES. THE ENGINEER SHALL BE NOTIFIED IN WRITING OF ANY UTILITIES INTERFERING WITH THE PROPOSED CONSTRUCTION AND APPROPRIATE REMEDIAL ACTION SHALL BE TAKEN BEFORE PROCEEDING. THE CONTRACTOR SHALL CALL THE ENGINEER IN THE EVENT OF THE CONTRACTOR'S INABILITY TO RELOCATE ALL EXISTING UTILITIES WHICH CONFLICT WITH THE PROPOSED IMPROVEMENTS SHOWN ON THE PLAN. | |
| 1.2. PROPERTY LINE AND TOPOGRAPHY: EXISTING PROPERTY LINE, UTILITY INFORMATION AND TOPOGRAPHY PROVIDED BY ANDREWS SURVEY & ENGINEERING, INC. SEE PLAN HEREIN. | |
| 1.3. DATUM: ASSUMED | |
| 1.4. BENCHMARKS: SEE PLANS | |
| 1.5. COORDINATE SYSTEM: ASSUMED | |
| 1.6. CONSTRUCTION STAKING CONTROL: THE CONTRACTOR SHALL BE RESPONSIBLE FOR ESTABLISHING AND MAINTAINING ALL CONTROL POINTS AND BENCH MARKS NECESSARY TO PERFORM THE WORK. | |
| 1.7. FLOODPLAIN: THE PROPERTY DOES NOT LIE IN A FLOOD HAZARD AREA OR 100-YEAR FLOODPLAIN ACCORDING TO THE MOST RECENT FLOOD INSURANCE RATE MAPS FOR BELLINGHAM. | |
| 2.0 DEMOLITION, SEDIMENTATION, AND EROSION CONTROL (STORMWATER POLLUTION PREVENTION PLAN) | |
| 2.1 GENERAL | |
| 2.1.1. THE FIRST STAGE INVOLVES ACTIVITIES NEEDED TO ADDRESS STORMWATER MANAGEMENT, EXCAVATING MATERIAL DESIGNATED FOR OFF-SITE REMOVAL OR ON-SITE RELOCATION AND FENCING OFF THE WORK AREA. THE CONTRACTOR WILL PREPARE SITE FOR CONVENTIONAL CONSTRUCTION. | |
| 2.1.2. THE SECOND STAGE WILL CONSIST OF ROUTINE CONSTRUCTION INVOLVING PAVING, LANDSCAPING, AND UTILITIES. | |
| 2.1.3. THERE ARE GENERAL PHASES OF CONSTRUCTION, IN EACH PHASE OF CONSTRUCTION, IMPLEMENT STANDARD EROSION AND SEDIMENT CONTROL PRACTICES PRIOR TO INITIATING EARTH DISTURBING ACTIVITIES, AND MAINTAIN THESE PRACTICES THROUGHOUT THE COURSE OF CONSTRUCTION. | |
| TYPICAL PRACTICES TO BE APPLIED TO THE SITE INCLUDE THE FOLLOWING: | |
| PRIOR TO EARTH DISTURBANCE IN ANY WORK AREA, INSTALL SEDIMENT BARRIERS (SILT FENCE WITH HAYBALES) BETWEEN THE WORK AREA AND THE SURFACE WATER RESOURCE TO WHICH IT DRAINS. | |
| PROVIDE TEMPORARY BERMS AND DRAINAGE CHANNELS TO DIVERT SURFACE WATER AWAY FROM THE AREAS THAT WILL BE EXPOSED BY CONSTRUCTION ACTIVITY. TOP OF CONCRETE DRAINS ARE TO BE USED WHERE SOILS CONTACT WITH EXPOSED SOILS. PROVIDE STABLE OUTLETS FOR THESE DEVICES, AND LINE OR VEGETATE THESE DIVERSIONS TO PROVIDE FOR THEIR STABILITY DURING CONSTRUCTION. | |
| LIMIT THE EXTENT OF EXPOSED SOILS TO AREAS THAT CAN BE WORKED AND RESTABILIZED WITHIN THE CONSTRUCTION SEASON AND DURING THE SPECIFIC CONSTRUCTION PHASE. | |
| WHEN EARTHWORK CONSTRUCTION ACTIVITY IN AN AREA IS COMPLETE, STABILIZE THE AREA WITH A SUITABLE SURFACE AS DESCRIBED BELOW. | |
| IN ADDITION TO THESE PRACTICES, FOLLOW THE SPECIAL PRACTICES DESCRIBED BELOW, WHICH ARE THE RESPONSIBILITY OF THE OWNER'S REPRESENTATIVE TO ADDRESS EROSION AND SEDIMENTATION CONDITIONS THAT MAY ARISE ON A CASE BY CASE BASIS DURING CONSTRUCTION. | |
| THE FOLLOWING IS A DESCRIPTION OF MINIMUM CONSTRUCTION REQUIREMENTS AND DOES NOT RELIEVE THE CONTRACTOR OF HIS RESPONSIBILITIES WITH REGARD TO DETERMINING THE ADEQUACY OF MEANS AND METHODS OF CONSTRUCTION. | |
| 2.2. CONSTRUCTION SEQUENCING | |
| SEQUENCING SHALL BE AS SHOWN ON THE PLAN AND AS DICTATED BY THE REQUIREMENTS OF CONSTRUCTION. | |
| 2.3. MAINTENANCE | |
| DURING THE PERIOD OF CONSTRUCTION AND/OR UNTIL LONG TERM VEGETATION IS ESTABLISHED: | |
| 2.3.1. SEEDED AREAS WILL BE FERTILIZED AND RESEED AS NECESSARY TO INSURE VEGETATION ESTABLISHMENT. | |
| 2.3.2. TEMPORARY DRAINAGE DRAINAGE CHANNELS WILL BE CHECKED WEEKLY AND REPAIRED WHEN NECESSARY. | |
| 2.3.3. THE HAYBALE AND SILTATION FENCING BARRIERS AND OTHER EROSION AND SEDIMENT CONTROL MEASURES/DEVICES SHALL BE INSPECTED, CLEANED, REPLACED AND/OR REPAIRED AS NECESSARY, PERIODICALLY AND AFTER EACH SIGNIFICANT RAINFALL. | |
| 2.4. GENERAL | |
| 2.4.1. ALL EROSION AND SEDIMENTATION CONTROL MEASURES SHALL BE CONSTRUCTED IN ACCORDANCE WITH (USDA) NATURAL RESOURCES CONSERVATION SERVICE (NRCS, FORMERLY SCS) GUIDELINES AND ALL LOCAL, COUNTY AND MUNICIPAL REGULATIONS. | |
| 2.4.2. THE CONTRACTOR SHALL BE RESPONSIBLE FOR ESTABLISHING AND MAINTAINING ALL CONTROL POINTS AND BENCH MARKS NECESSARY FOR THE WORK. | |
| 2.4.3. EROSION AND SEDIMENTATION CONTROL MEASURES SHALL BE IN PLACE PRIOR TO THE COMMENCEMENT OF ANY SITE WORK OR EARTHWORK OPERATIONS, SHALL BE MAINTAINED DURING CONSTRUCTION, AND SHALL REMAIN IN PLACE UNTIL ALL SITE WORK IS COMPLETE AND GROUNDCOVER IS ESTABLISHED. | |
| 2.4.4. ALL WORK SHALL BE IN ACCORDANCE WITH THE PERMITS AND APPROVALS ISSUED AND THE CONSTRUCTION SPECIFICATIONS. | |
| 2.4.5. STOCKPILES SHALL BE SURROUNDED ON THEIR PERIMETERS WITH STAKED HAYBALES AND/OR SILTATION FENCES TO PREVENT AND/OR CONTROL SILTATION AND EROSION. | |
| 2.4.6. TOPS OF STOCKPILES SHALL BE COVERED IN SUCH A MANNER THAT STORMWATER DOES NOT INTRUDER ON MATERIALS AND THEREBY RENDER THE SAME UNSUITABLE FOR FILL USE. | |
| 2.4.7. ALL DISTURBED OR EXPOSED AREAS SUBJECT TO EROSION SHALL BE RESEEDED AS SOON AS POSSIBLE, WHICH SHALL BE AT LEAST 100% VEGETATION COVER. NO AREA SUBJECT TO EROSION SHALL BE LEFT DISTURBED AND UNSTABILIZED FOR PERIODS LONGER THAN IS ABSOLUTELY NECESSARY TO CARRY OUT THAT PORTION OF THE CONSTRUCTION WORK. | |
| 2.4.8. HAYBALE DIKES SHALL BE CONSTRUCTED AT ALL EXISTING & PROPOSED DIKE LINES LOCATED IN FILL AREAS & SUBJECT TO STORMWATER RUN-OFF FROM PROPOSED FILL AREAS DURING CONSTRUCTION, OR AS DIRECTED BY THE OWNER'S REPRESENTATIVE, NO SEDIMENTS SHALL ENTER THE ON-SITE OR OFF-SITE DRAINAGE SYSTEMS AT ANY TIME. | |
| 2.4.9. HAYBALES SHALL BE PERIODICALLY INSPECTED AND REPLACED AS REQUIRED. | |

| LEGEND | |
|--------|-----------------------|
| SYMBOL | DESCRIPTION |
| □ | CATCH BASIN |
| ○ | UTILITY POLE |
| × | GAS VALVE |
| ■ | WATER VALVE |
| △ | HYDRANT |
| ◎ | DRAIN MANHOLE |
| ◎ | SEWER MANHOLE |
| ◎ | WELL |
| ◎ | LIGHT POLE |
| — | DRAIN LINE |
| — | SEWER LINE |
| — | WATER LINE |
| — | OVERHEAD WIRES |
| — | TREE LINE |
| — | OBSTRUCTION TEST HOLE |

ASE
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Land Surveying - Civil Engineering - Site Planning
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APPROVAL UNDER SUBDIVISION CONTROL LAW
REQUIRED. BELLINGHAM PLANNING BOARD

Reed Hall
Tim Hall
Devin Hall

BEING A MAJORITY DATE: 6/16/17

TOWN CLERK: DATE

| ABBREVIATIONS | |
|---------------|---------------------------|
| ITEM | DESCRIPTION |
| S.F. | SQUARE FEET |
| N/F | NOW OR FORMERLY |
| TOC | TOP OF CONCRETE |
| GAR. | GARAGE |
| EXIST. | EXISTING |
| PROP. | PROPOSED |
| DMH | DRAIN MANHOLE |
| SMH | SEWER MANHOLE |
| CB | CATCH BASIN |
| CCB | CAPE COD BERM |
| EOP | EDGE OF PAVEMENT |
| PVC | POLYVINYL CHLORIDE PIPE |
| FES | FLARED END SECTION |
| HDPE | HIGH DENSITY POLYETHYLENE |
| INV. | INVERT |
| TYP. | TYPICAL |
| BIT. | BITUMINOUS |
| CONC. | CONCRETE |
| RET. | RETAINING |
| TBM | TEMPORARY BENCH MARK |
| x 211.5 | SPOT GRADE |

| REVISIONS | |
|-------------|---|
| NO. | DATE |
| 1. | 6/7/17 PLANNING & PEER REVIEW COMMENTS |
| 2 | 6/22/17 NATIONAL GRID REQUIREMENTS |
| 3 | 6/26/17 NATIONAL GRID COMMENTS |
| 4 | 7/06/17 NATIONAL GRID COMMENTS |
| 5 | 9/26/17 PEER REVIEW COMMENTS |
| 6 | 10/18/17 PEER REVIEW COMMENTS |
| 7 | 11/03/17 PEER REVIEW COMMENTS |
| 8 | 1/05/18 FIRE DEPT. COMMENTS |
| 9 | 3/20/18 PLANNING & PEER REVIEW COMMENTS |
| 10 | 4/23/18 PER PEER REVIEW COMMENTS |
| 11 | 5/8/18 PER CONDITIONS OF APPROVAL |
| DRAWN BY | WON, TRB, SJO |
| CHECKED BY | PBH, RMM |
| DATE | FEBRUARY 2, 2017 |
| PROJECT NO. | 2015-110 |




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| LEGEND, | DRAWING NO. |
| ABBREVIATIONS, | |
| & GENERAL NOTES | |


5/16/17

JOHN J. WASYLEAN, JR.
DEFINITIVE SUBDIVISION
799-801 PULASKI BLVD.
BELLINGHAM, MA 02019
APPLICANT:

C-1.0

PLAN NO. L-4910
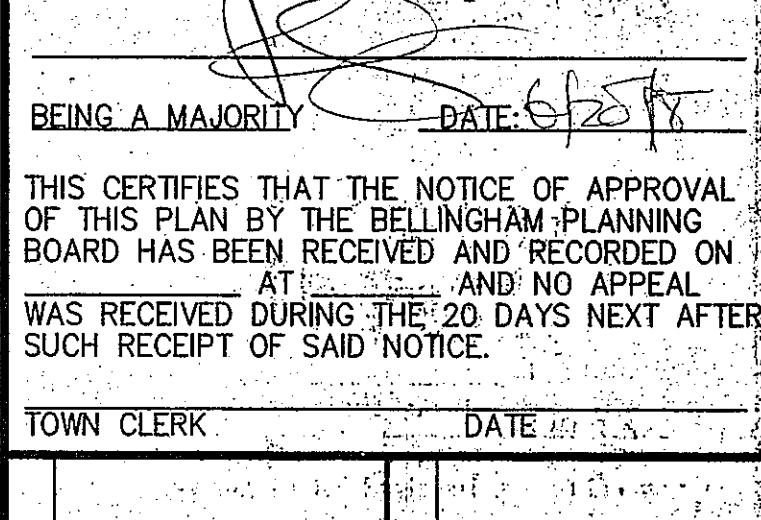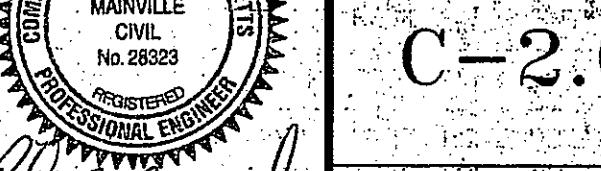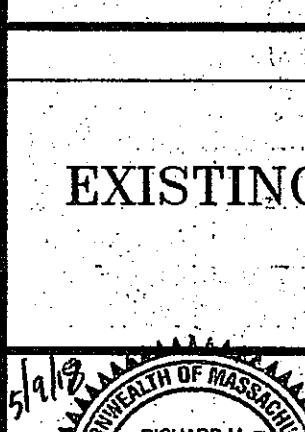
|  <p>Andrews Survey & Engineering, Inc. Land Surveying - Civil Engineering - Site Planning</p> | | | | | | | | | | | | | | | | | | | | | | | | | | | | | | | | | | | | | |
|--|---|---------------------------------|------|-------------|---|--------|---------------------------------|---|---------|----------------------------|---|---------|------------------------|---|---------|------------------------|---|---------|----------------------|---|----------|----------------------|---|----------|----------------------|---|---------|---------------------|---|---------|---------------------------------|----|---------|--------------------------|----|--------|----------------------------|
| <p>P.O. Box 312, 104 Mendon Street BELLINGHAM, Massachusetts 01569-0312 P: 508-278-3897 F: 508-278-2289</p> | | | | | | | | | | | | | | | | | | | | | | | | | | | | | | | | | | | | | |
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| <p>APPROVAL UNDER SUBDIVISION CONTROL LAW REQUIRED. BELLINGHAM PLANNING BOARD</p> | | 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| <p>BEING A MAJORITY DATE: 6/28/18</p> | | | | | | | | | | | | | | | | | | | | | | | | | | | | | | | | | | | | | |
| <p>THIS CERTIFIES THAT THE NOTICE OF APPROVAL OF THIS PLAN BY THE BELLINGHAM PLANNING BOARD HAS BEEN RECEIVED AND RECORDED ON AT _____ AND NO APPEAL WAS RECEIVED DURING THE 20 DAYS NEXT AFTER SUCH RECEIPT OF SAID NOTICE.</p> | | | <p>TOWN CLERK DATE</p> | | | | | | | | | | | | | | | | | | | | | | | | | | | | | | | | | | | | | |
| <p>PROJECT:</p> | <p>NERINA ESTATES DEFINITIVE SUBDIVISION 799-801 PULASKI BLVD. BELLINGHAM, MA 02019</p> | | | | | | | | | | | | | | | | | | | | | | | | | | | | | | | | | | | | |
| <p>APPLICANT:</p> | <p>JOHN J. WASYLEAN, JR. 799-801 PULASKI BLVD. BELLINGHAM, MA 02019</p> | | | | | | | | | | | | | | | | | | | | | | | | | | | | | | | | | | | | |
| <p>REVISIONS</p> | | | | | | | | | | | | | | | | | | | | | | | | | | | | | | | | | | | | | |
| <table border="1" style="width: 100%; border-collapse: collapse;"> <thead> <tr> <th style="width: 10%;">NO.</th> <th style="width: 10%;">DATE</th> <th style="width: 80%;">DESCRIPTION</th> </tr> </thead> <tbody> <tr> <td>1</td> <td>6/7/17</td> <td>PLANNING & PEER REVIEW COMMENTS</td> </tr> <tr> <td>2</td> <td>6/22/17</td> <td>NATIONAL GRID REQUIREMENTS</td> </tr> <tr> <td>3</td> <td>6/26/17</td> <td>NATIONAL GRID COMMENTS</td> </tr> <tr> <td>4</td> <td>7/06/17</td> <td>NATIONAL GRID COMMENTS</td> </tr> <tr> <td>5</td> <td>9/26/17</td> <td>PEER REVIEW COMMENTS</td> </tr> <tr> <td>6</td> <td>10/18/17</td> <td>PEER REVIEW COMMENTS</td> </tr> <tr> <td>7</td> <td>11/03/17</td> <td>PEER REVIEW COMMENTS</td> </tr> <tr> <td>8</td> <td>1/05/18</td> <td>FIRE DEPT. COMMENTS</td> </tr> <tr> <td>9</td> <td>3/20/18</td> <td>PLANNING & PEER REVIEW COMMENTS</td> </tr> <tr> <td>10</td> <td>4/23/18</td> <td>PER PEER REVIEW COMMENTS</td> </tr> <tr> <td>11</td> <td>5/8/18</td> <td>PER CONDITIONS OF APPROVAL</td> </tr> </tbody> </table> | | NO. | DATE | DESCRIPTION | 1 | 6/7/17 | PLANNING & PEER REVIEW COMMENTS | 2 | 6/22/17 | NATIONAL GRID REQUIREMENTS | 3 | 6/26/17 | NATIONAL GRID COMMENTS | 4 | 7/06/17 | NATIONAL GRID COMMENTS | 5 | 9/26/17 | PEER REVIEW COMMENTS | 6 | 10/18/17 | PEER REVIEW COMMENTS | 7 | 11/03/17 | PEER REVIEW COMMENTS | 8 | 1/05/18 | FIRE DEPT. COMMENTS | 9 | 3/20/18 | PLANNING & PEER REVIEW COMMENTS | 10 | 4/23/18 | PER PEER REVIEW COMMENTS | 11 | 5/8/18 | PER CONDITIONS OF APPROVAL |
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| 11 | 5/8/18 | PER CONDITIONS OF APPROVAL | | | | | | | | | | | | | | | | | | | | | | | | | | | | | | | | | | | |
| <p>DRAWN BY: WCN, TRB, SJO</p> | | | | | | | | | | | | | | | | | | | | | | | | | | | | | | | | | | | | | |
| <p>CHECKED BY: PBH, RMM, BJA</p> | | | | | | | | | | | | | | | | | | | | | | | | | | | | | | | | | | | | | |
| <p>DATE: FEBRUARY 2, 2017</p> | | | | | | | | | | | | | | | | | | | | | | | | | | | | | | | | | | | | | |
| <p>PROJECT NO.: 2015-110</p> | | | | | | | | | | | | | | | | | | | | | | | | | | | | | | | | | | | | | |
| <p>GRAPHIC SCALE</p> | | | | | | | | | | | | | | | | | | | | | | | | | | | | | | | | | | | | | |
|  <p>40 0 20 40 80 (IN FEET) 1 inch = 40 Feet</p> | | | | | | | | | | | | | | | | | | | | | | | | | | | | | | | | | | | | | |
| <p>SHEET TITLE</p> | | | | | | | | | | | | | | | | | | | | | | | | | | | | | | | | | | | | | |
| <p>EXISTING CONDITIONS PLAN</p> | | | | | | | | | | | | | | | | | | | | | | | | | | | | | | | | | | | | | |
|  | <p>DRAWING NO. C-2.0</p> | | | | | | | | | | | | | | | | | | | | | | | | | | | | | | | | | | | | |
| <p>PLAN NO. 1-4910</p> | | | | | | | | | | | | | | | | | | | | | | | | | | | | | | | | | | | | | |

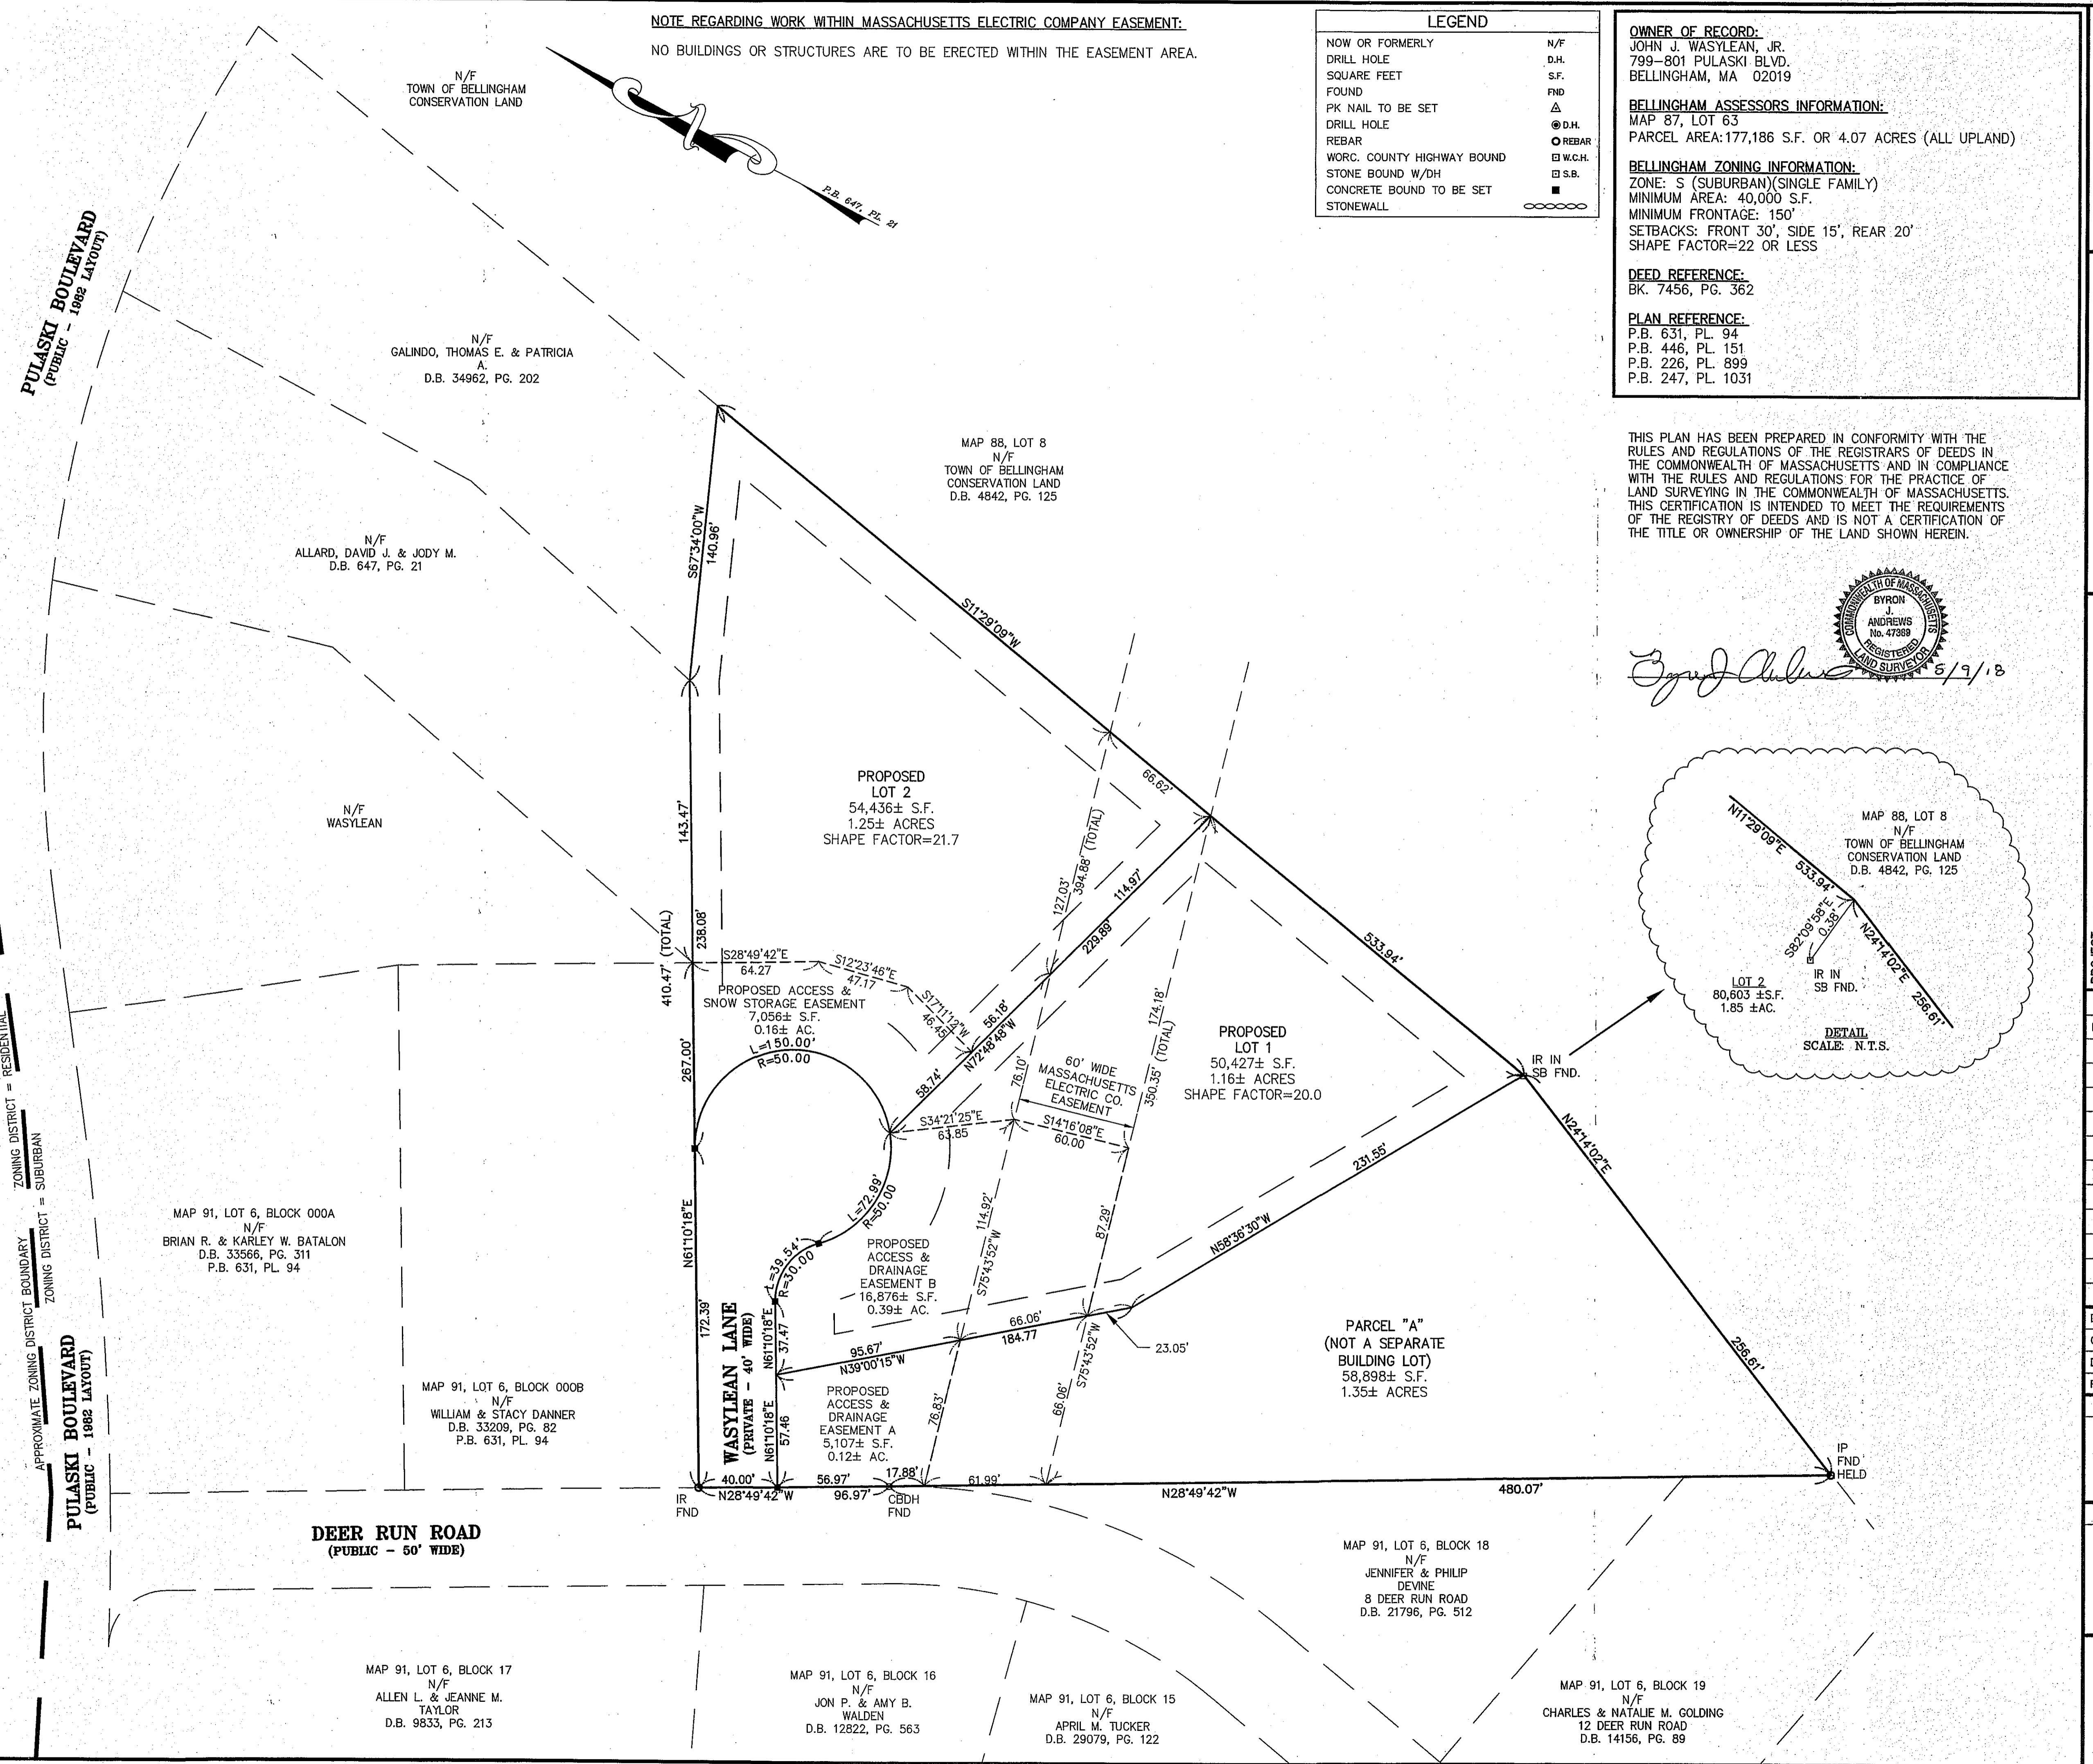



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APPROVAL UNDER SUBDIVISION CONTROL LAW
REQUIRED: BELLINGHAM PLANNING BOARD

Wendy [Signature]
Debra [Signature]
Deb [Signature]

BEING A MAJORITY DATE: 2/27/17

THIS CERTIFIES THAT THE NOTICE OF APPROVAL
OF THIS PLAN BY THE BELLINGHAM PLANNING
BOARD HAS BEEN RECEIVED AND RECORDED ON
AT: 2/27/17 AND NO APPEAL
WAS RECEIVED DURING THE 20 DAYS NEXT AFTER
SUCH RECEIPT OF SAID NOTICE.

TOWN CLERK DATE:

| | |
|------------------------|-----------------------|
| PROJECT: | NERINA ESTATES |
| APPLICANT: | JOHN J. WASYLEAN, JR. |
| DEFINITIVE SUBDIVISION | |
| 799-801 PULASKI BLVD. | |
| BELLINGHAM, MA 02019 | |

REVISIONS

| NO. | DATE | DESCRIPTION |
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| 11 | 5/8/18 | PER CONDITIONS OF APPROVAL |


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CHECKED BY: PBH, RMM.

DATE: FEBRUARY 2, 2017


PROJECT NO: 2015-110

GRAPHIC SCALE

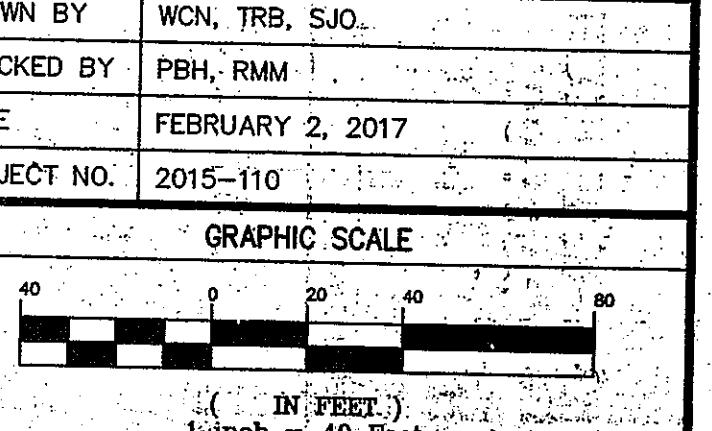

SHEET TITLE

TOPOGRAPHIC, UTILITY
& EROSION CONTROL
PLAN

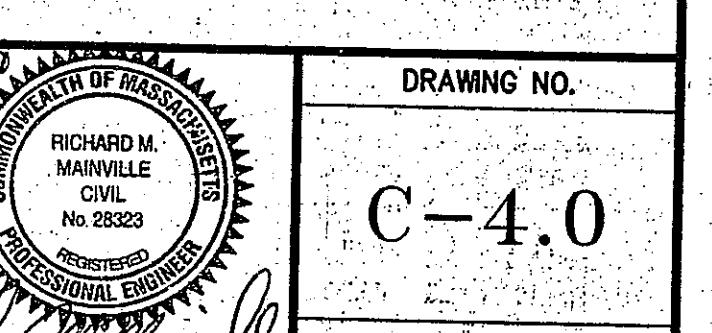

DRAWING NO.

C-4.0

PLAN NO. L-4910


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|------------|---|
| PROJECT: | NERINA ESTATES DEFINITIVE SUBDIVISION 799-801 PULASKI BLVD. BELLINGHAM, MA 02019 |
| APPLICANT: | JOHN J. WASYLEAN, JR. 799-801 PULASKI BLVD. BELLINGHAM, MA 02019 |

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| | |
|-------------|----------------------|
| DRAWN BY | WCN, TRB, SJO |
| CHECKED BY | PBH, RMM |
| DATE | FEBRUARY 2, 2017 |
| PROJECT NO. | 2015-110 |
| SHEET TITLE | CONSTRUCTION DETAILS |


1/19
CITY OF BELLINGHAM
CIVIL ENGINEERING
SPECIALIST

DRAWING NO.: C-6.0
PLAN NO.: L-4910

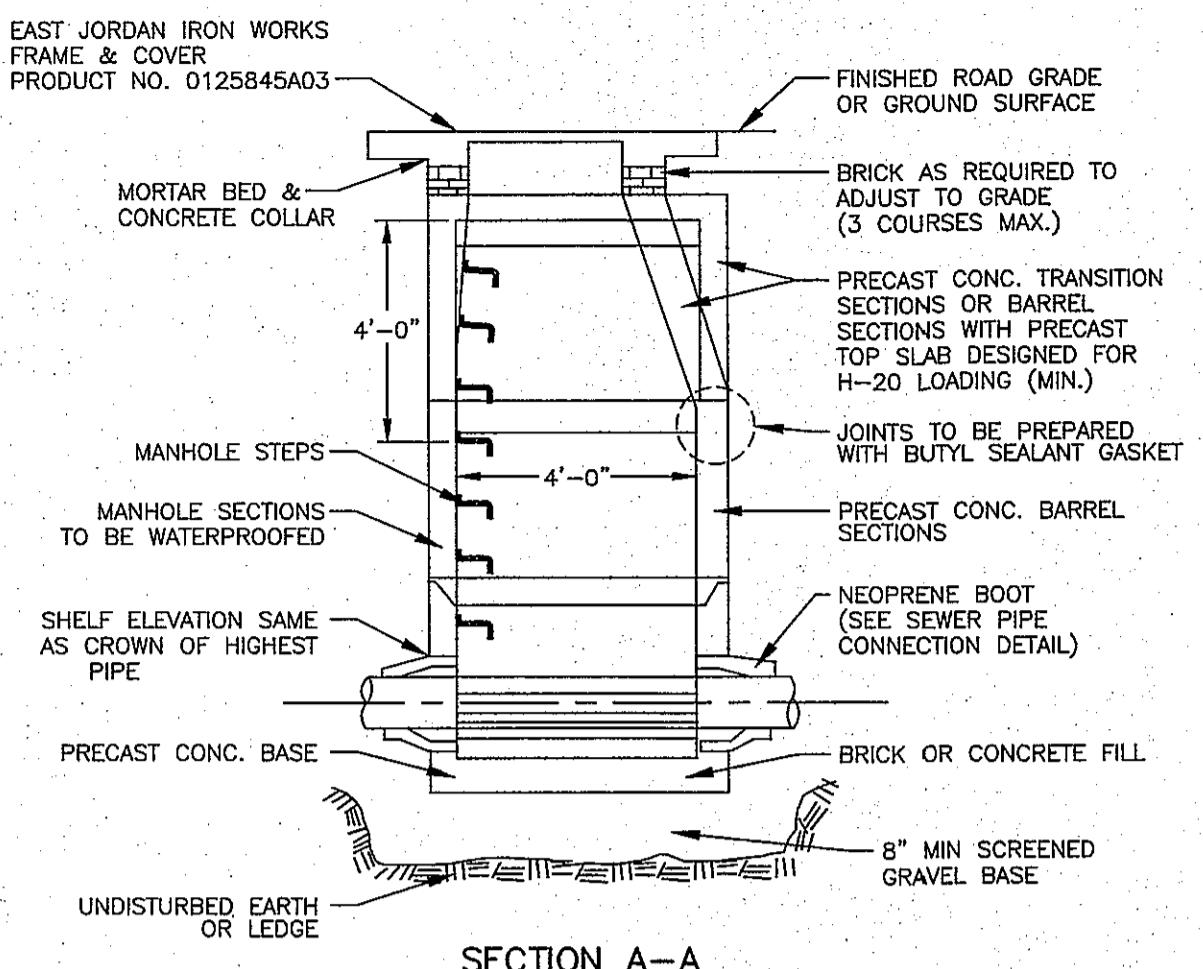


1 TYPICAL PRECAST CONCRETE 48" DIAMETER SEWER MANHOLE (SMH)

SCALE: N.T.S.

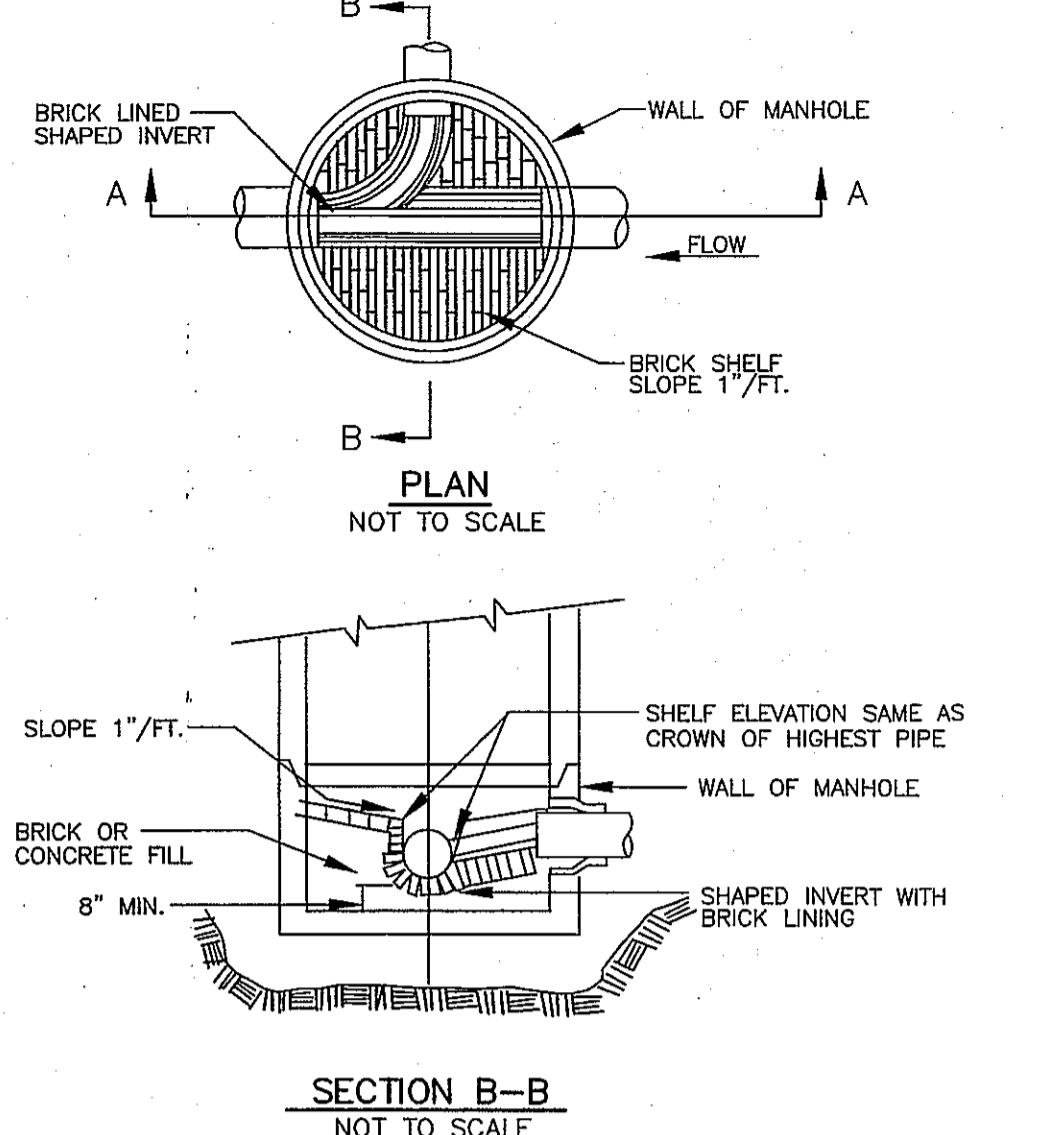



2 DRAINAGE CHANNEL

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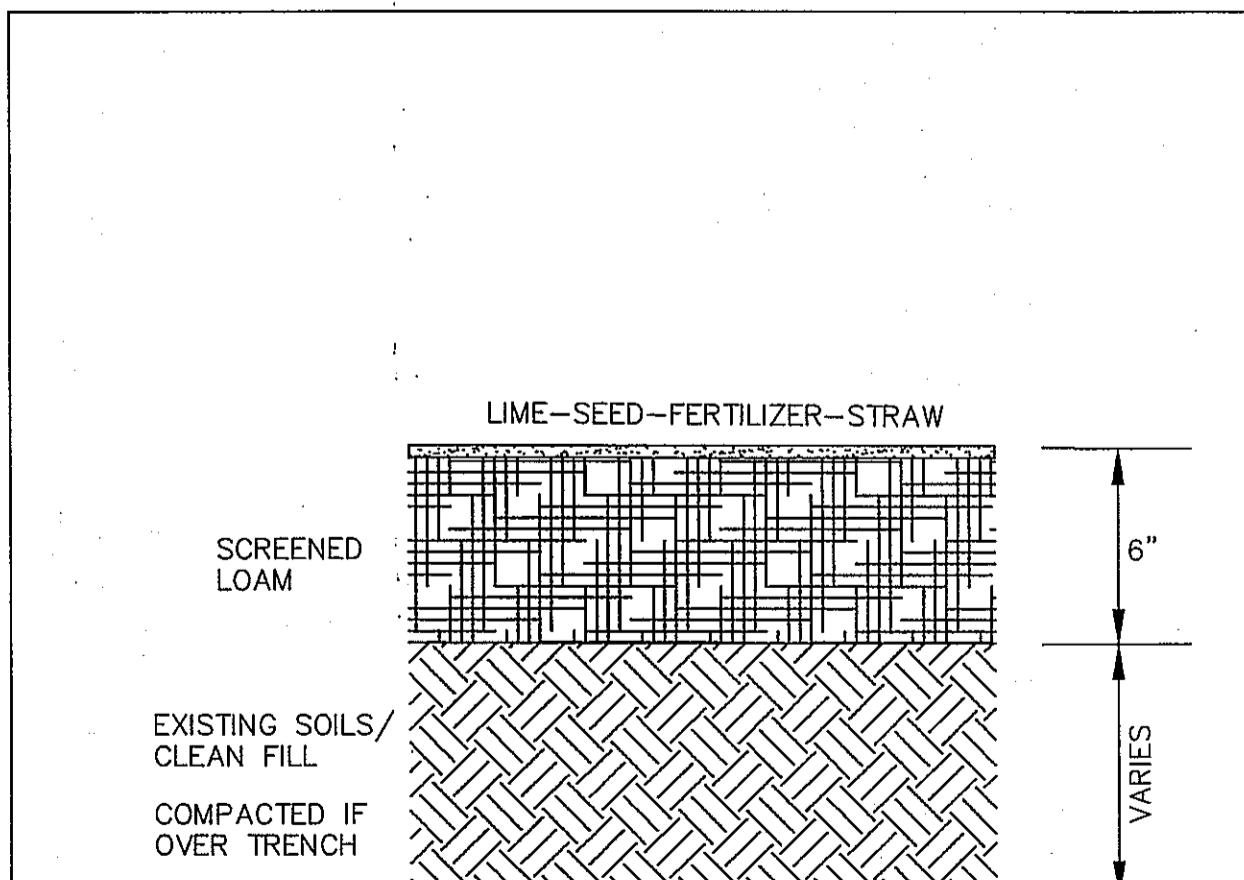
4 ROADWAY CROSS SECTION
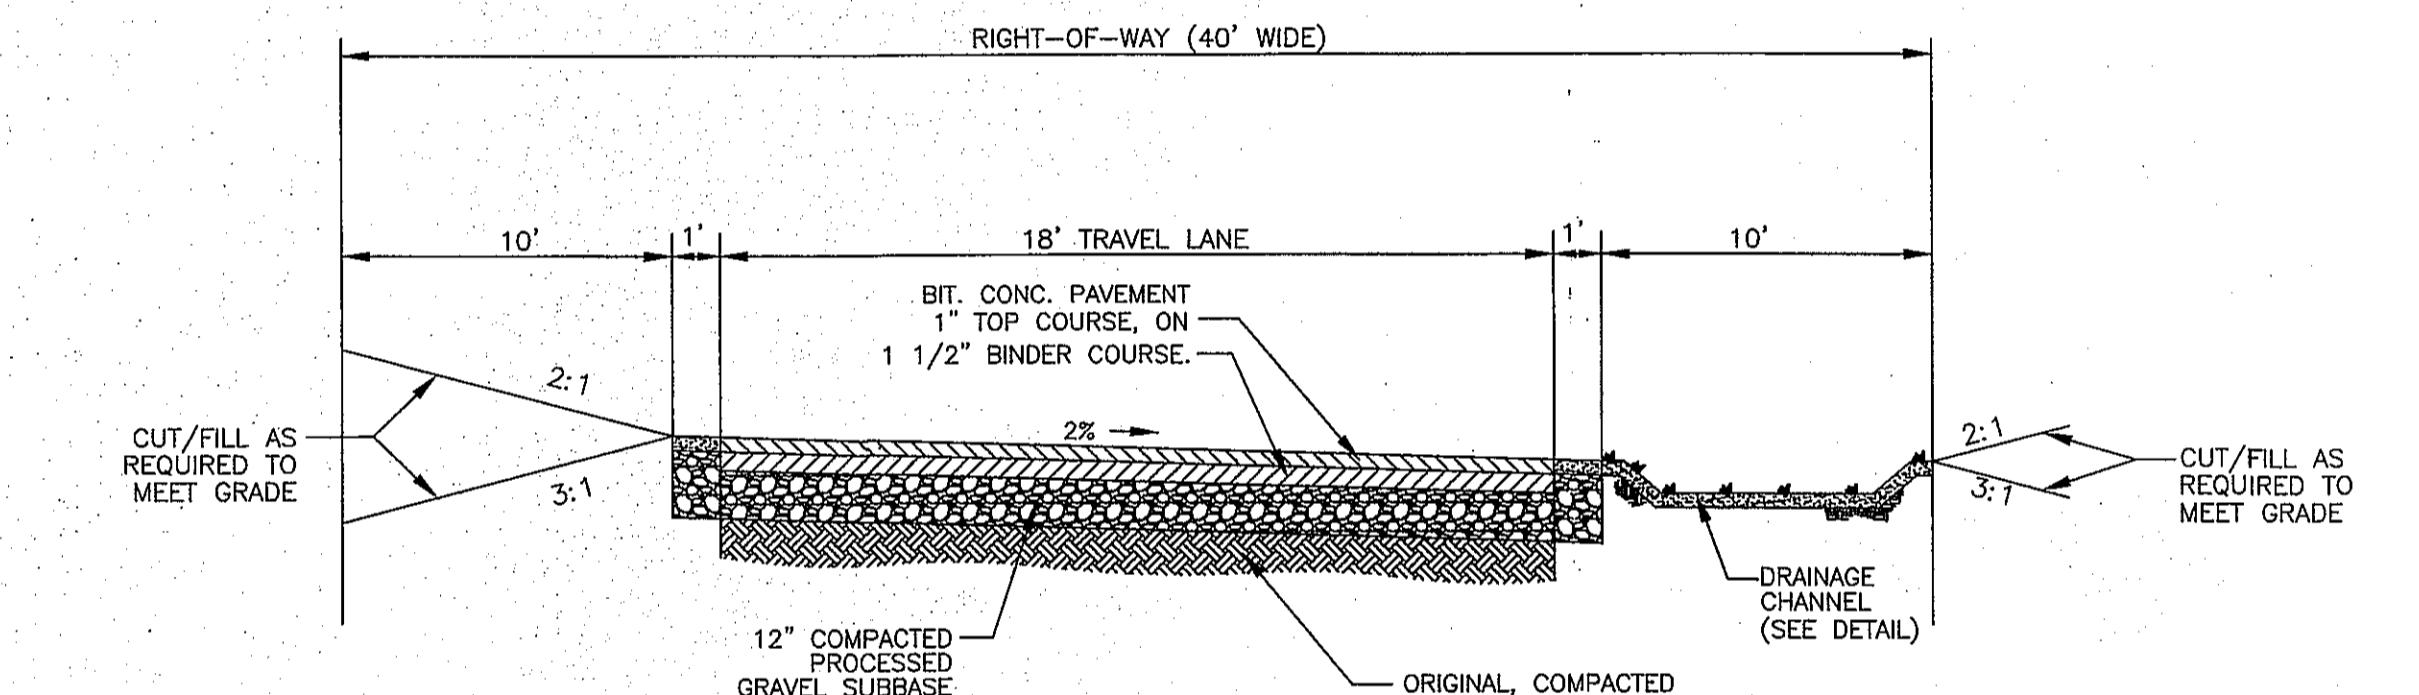
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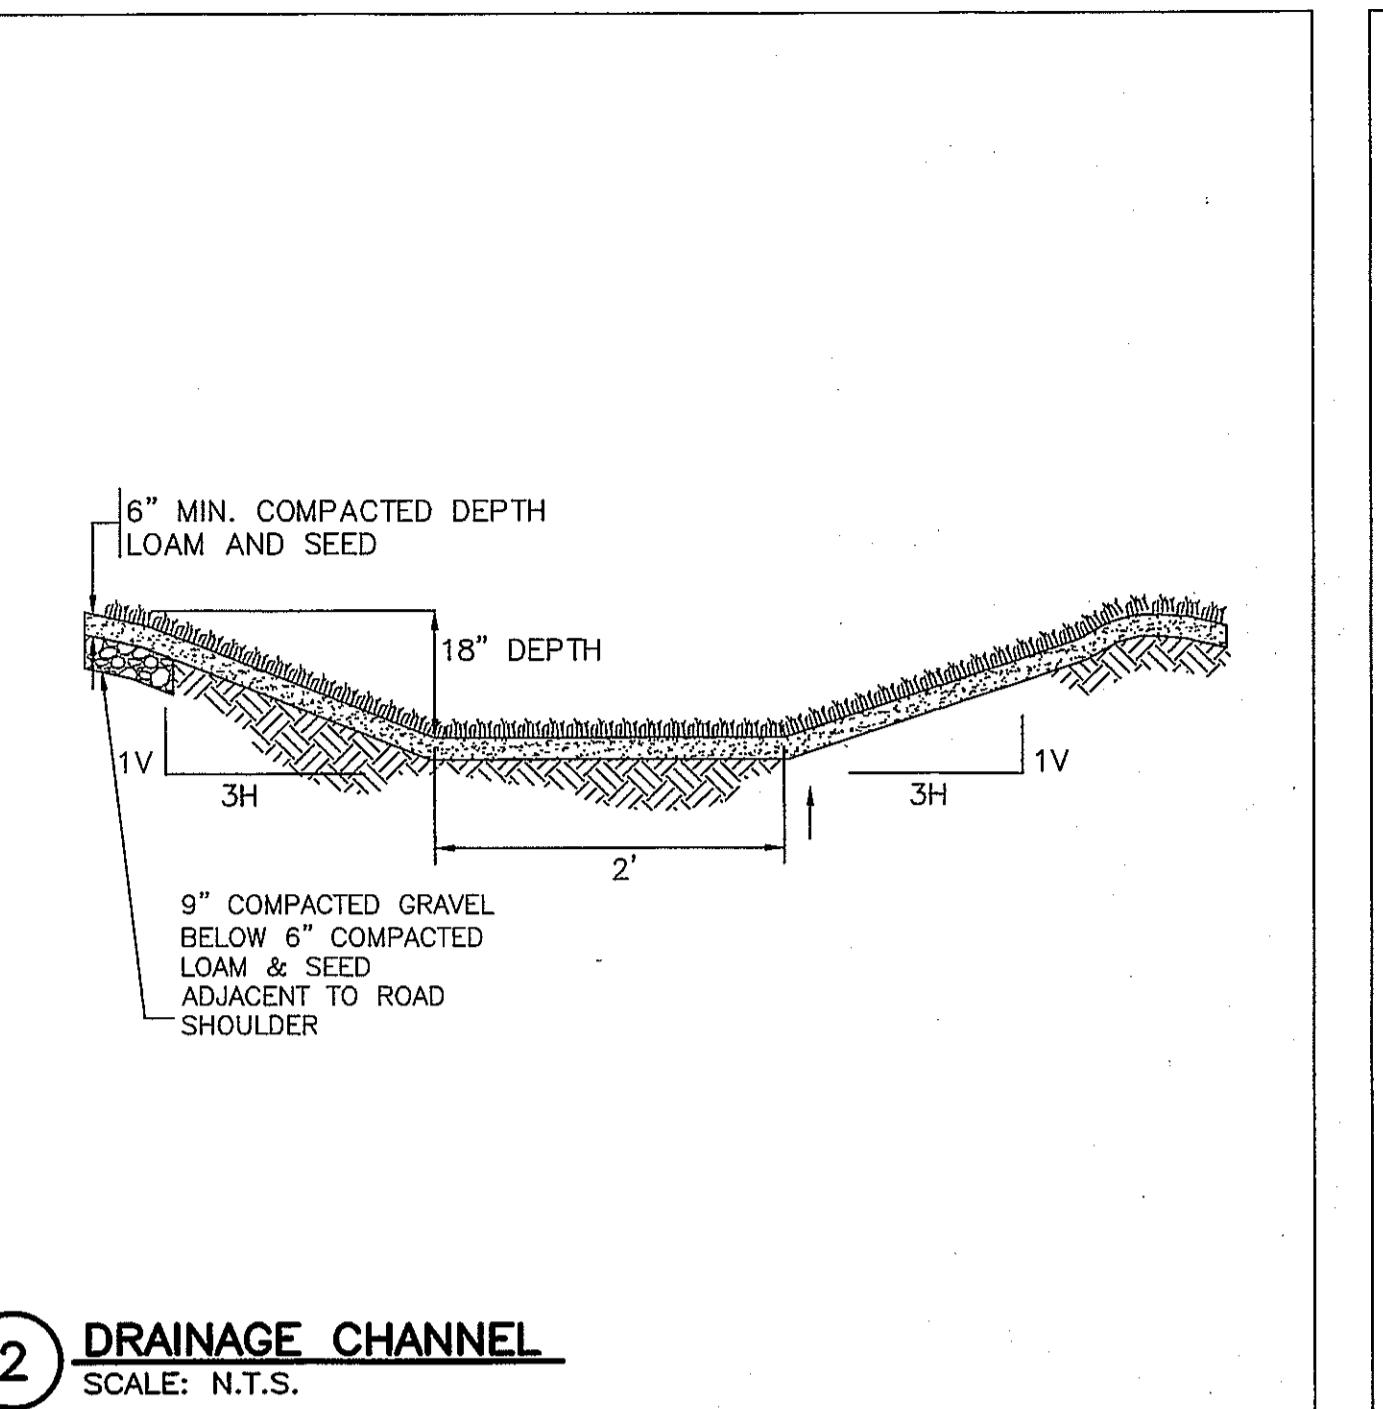
7 TYPICAL UTILITY TRENCH DETAIL

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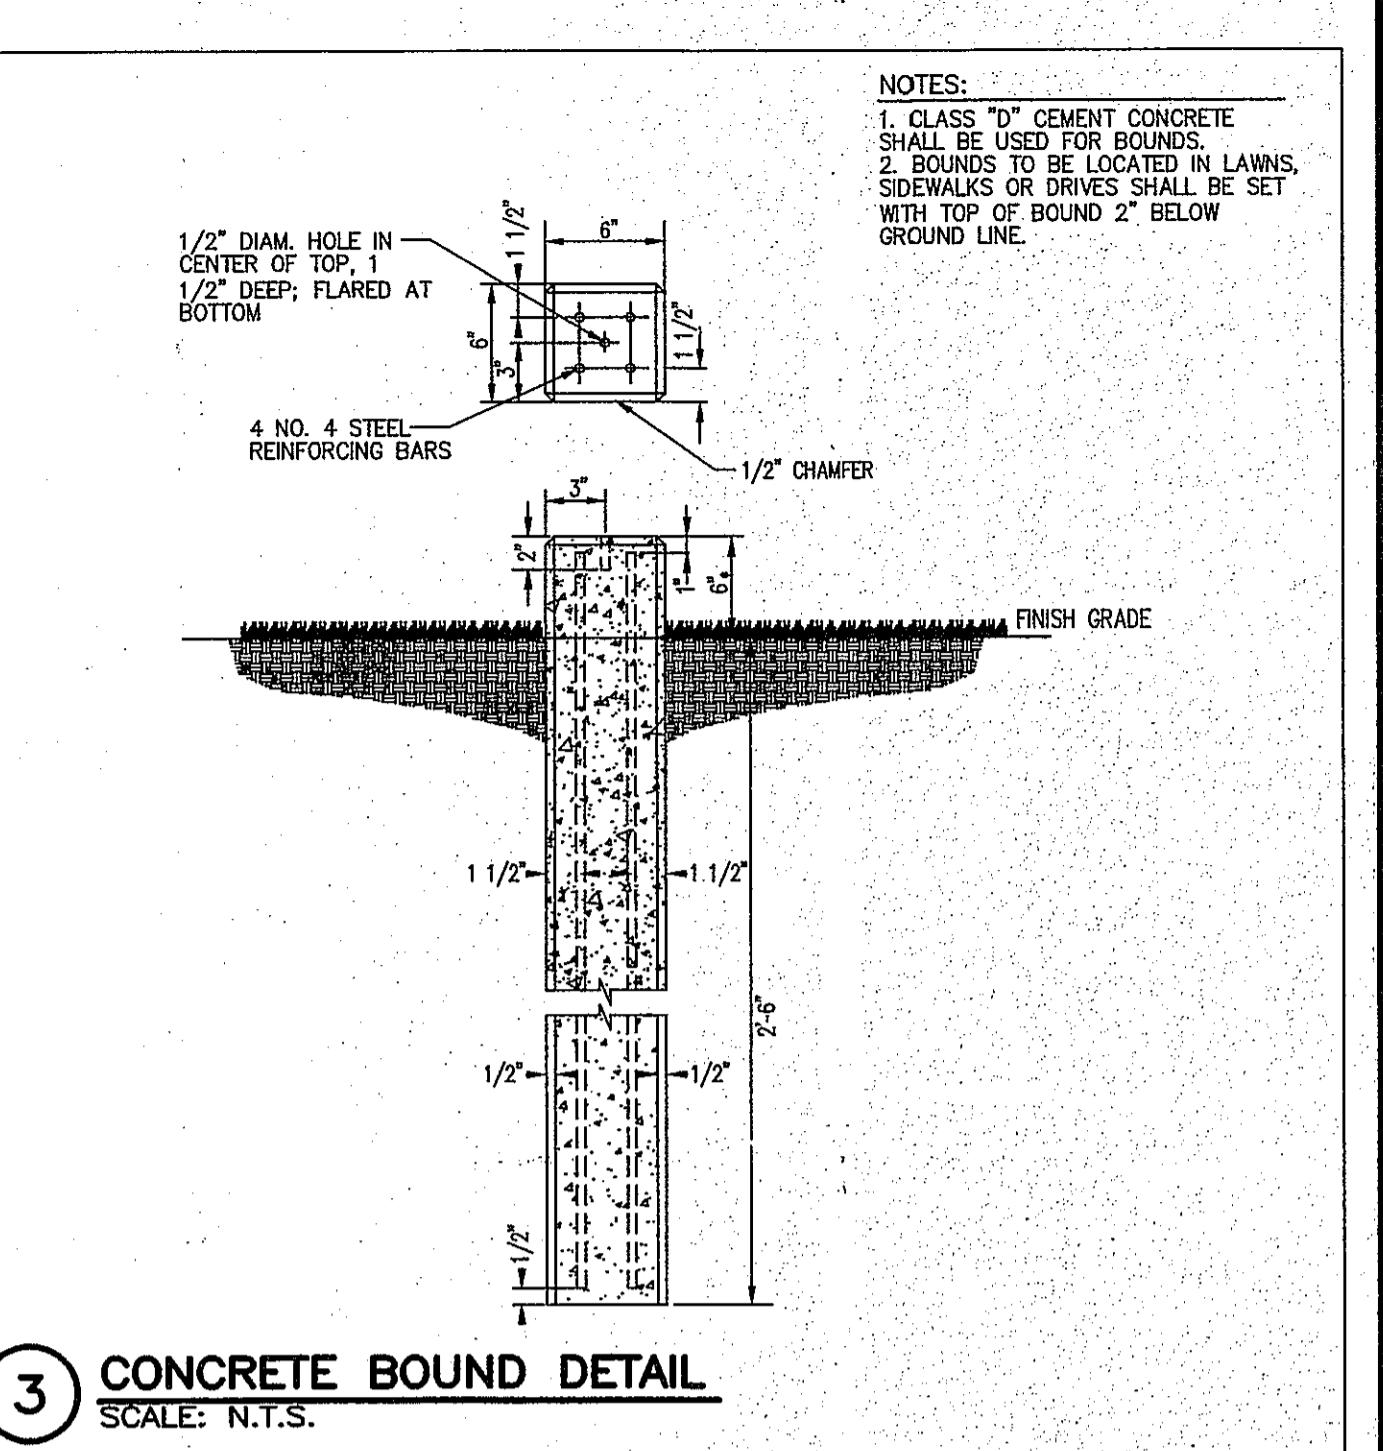
8 LOAM & SEED DETAIL

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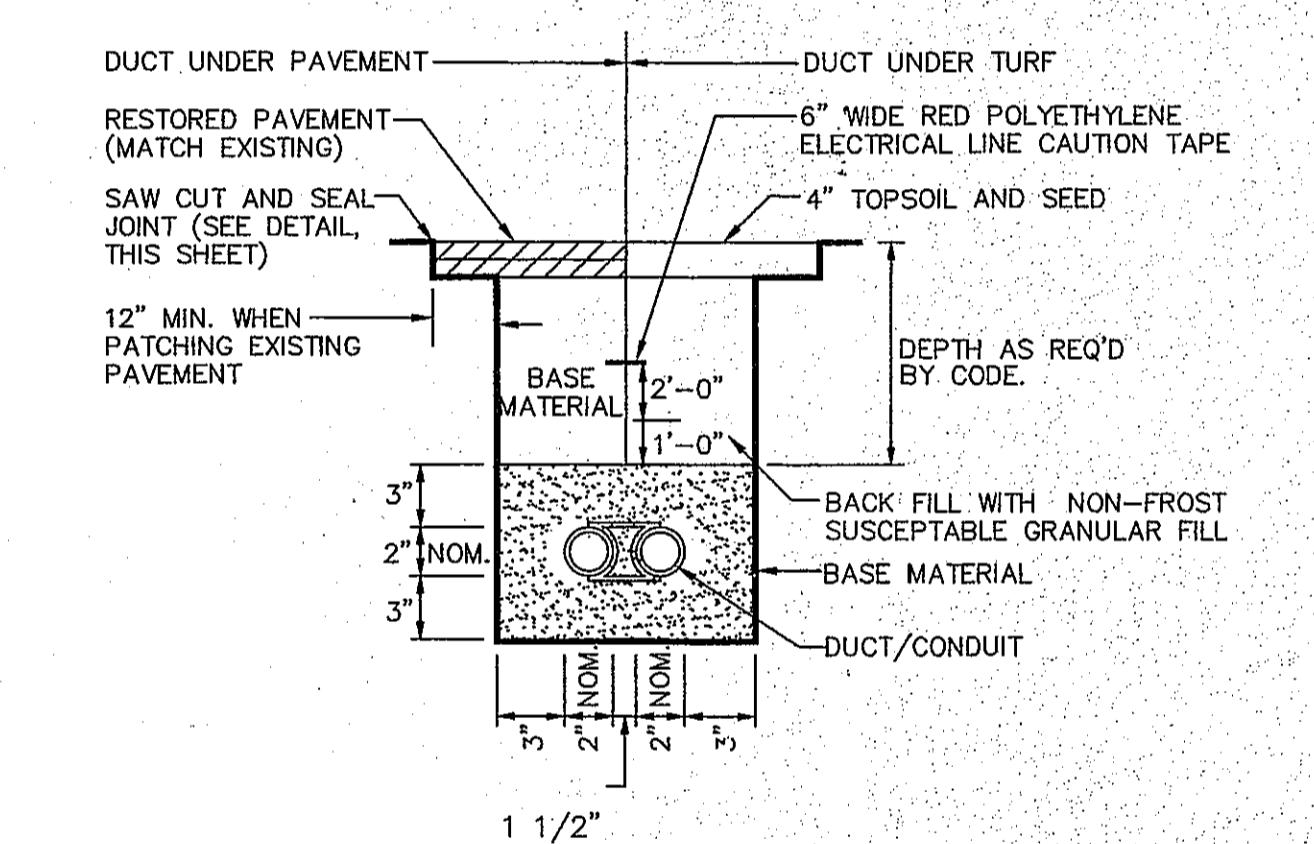
9 TYPICAL WATER SERVICE DETAIL
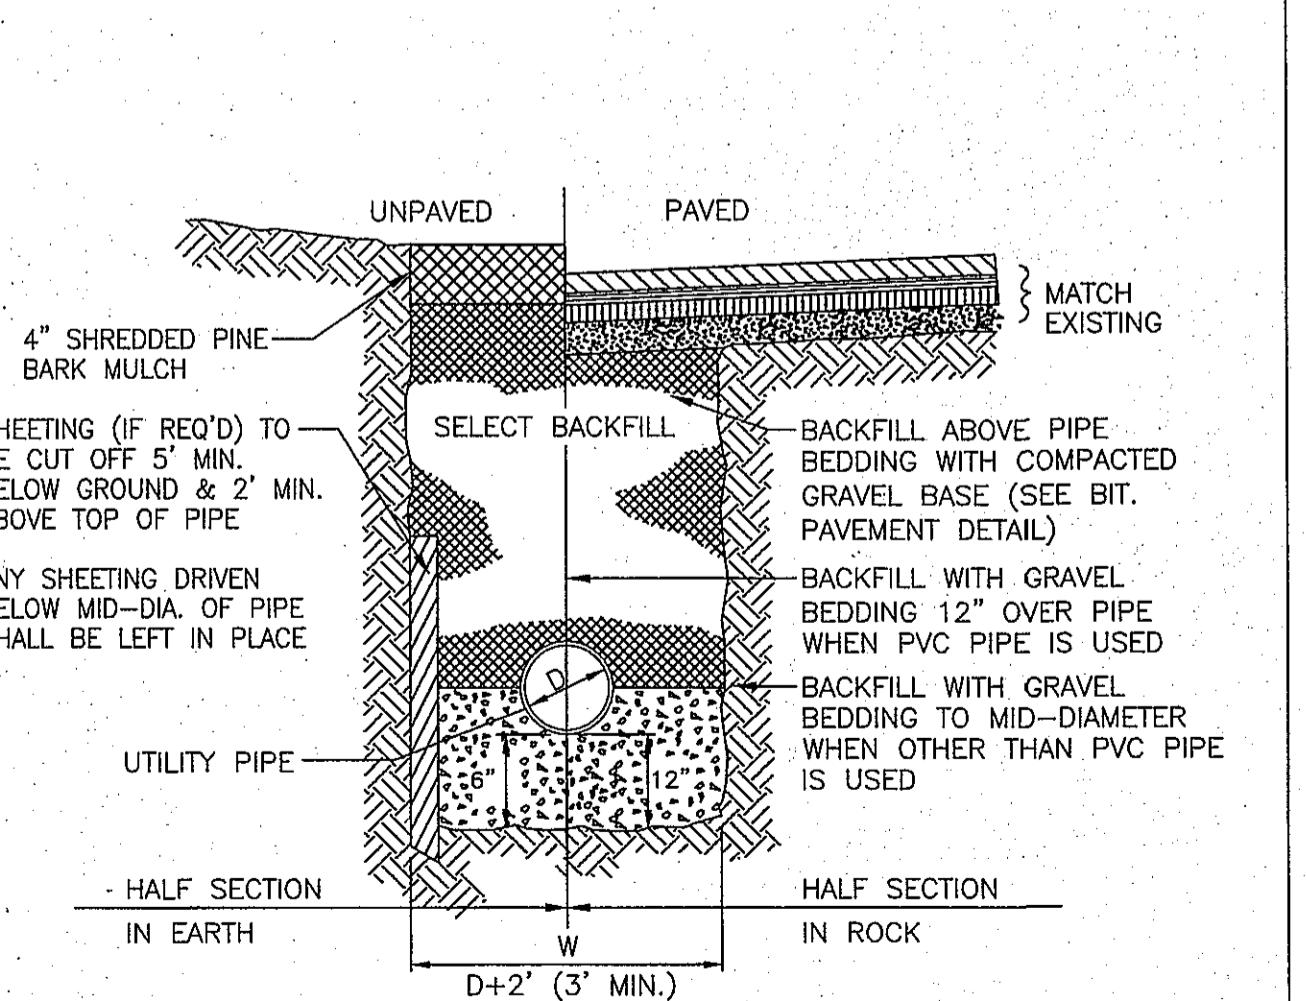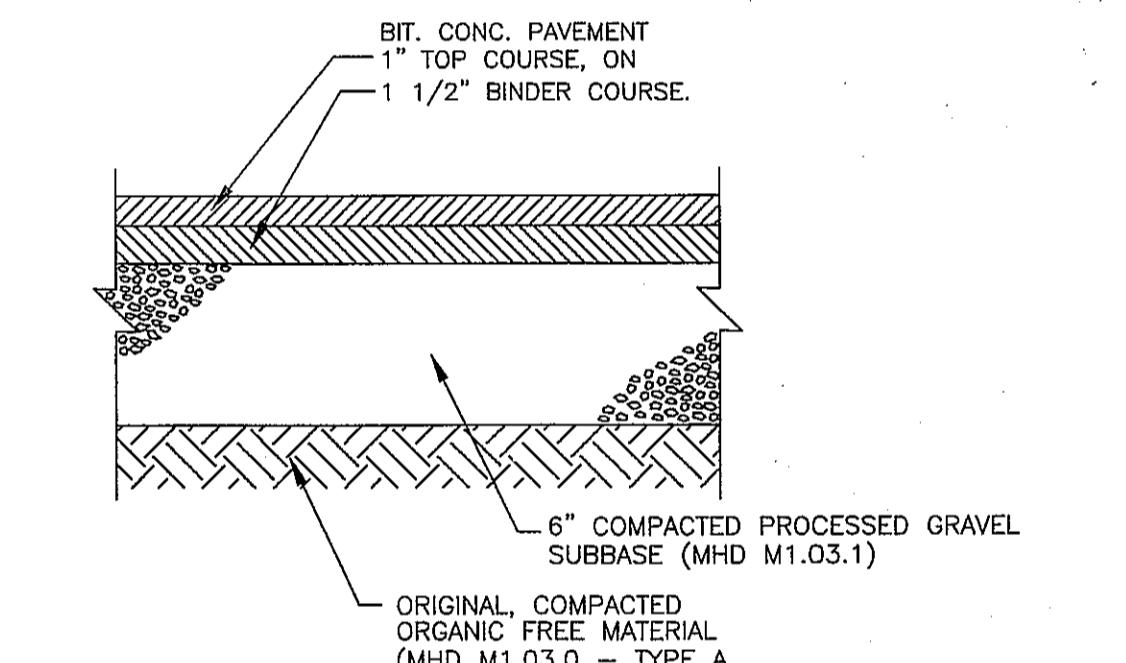
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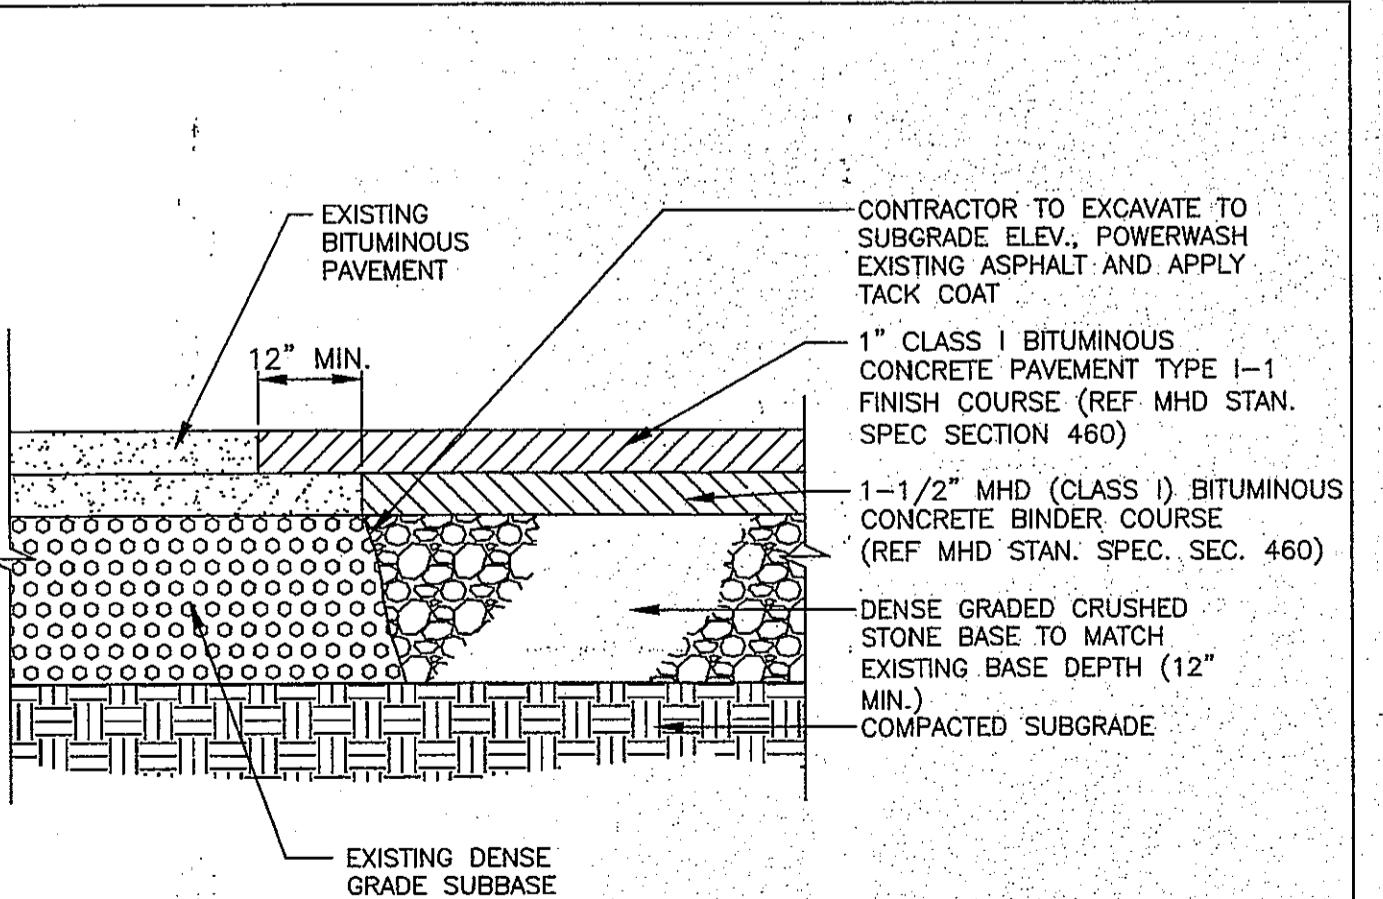
3 CONCRETE BOUND DETAIL

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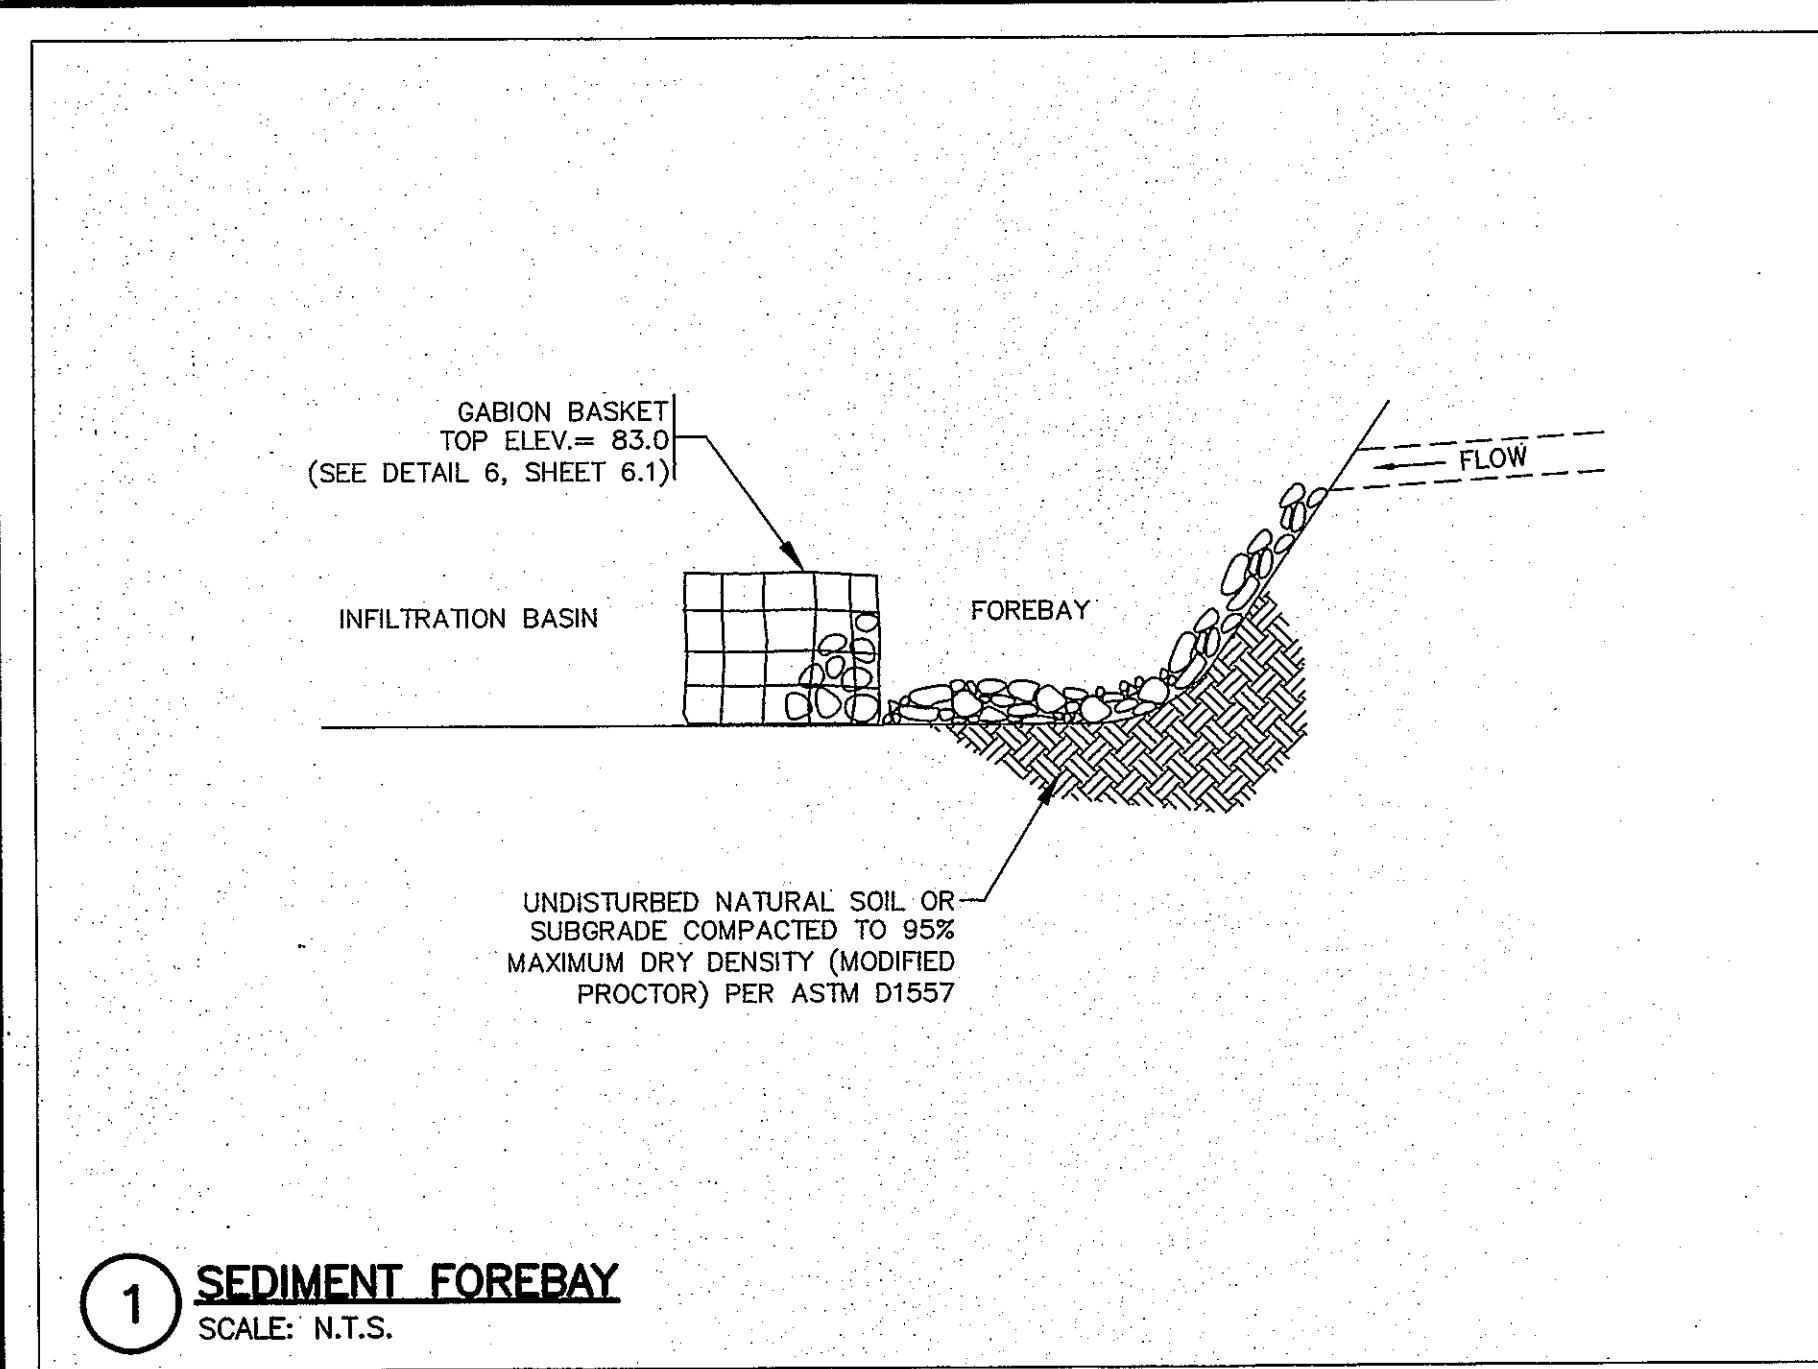
6 UNENCASED DUCT/CONDUIT DETAIL

SCALE: N.T.S.




10 PAVEMENT JOINTING

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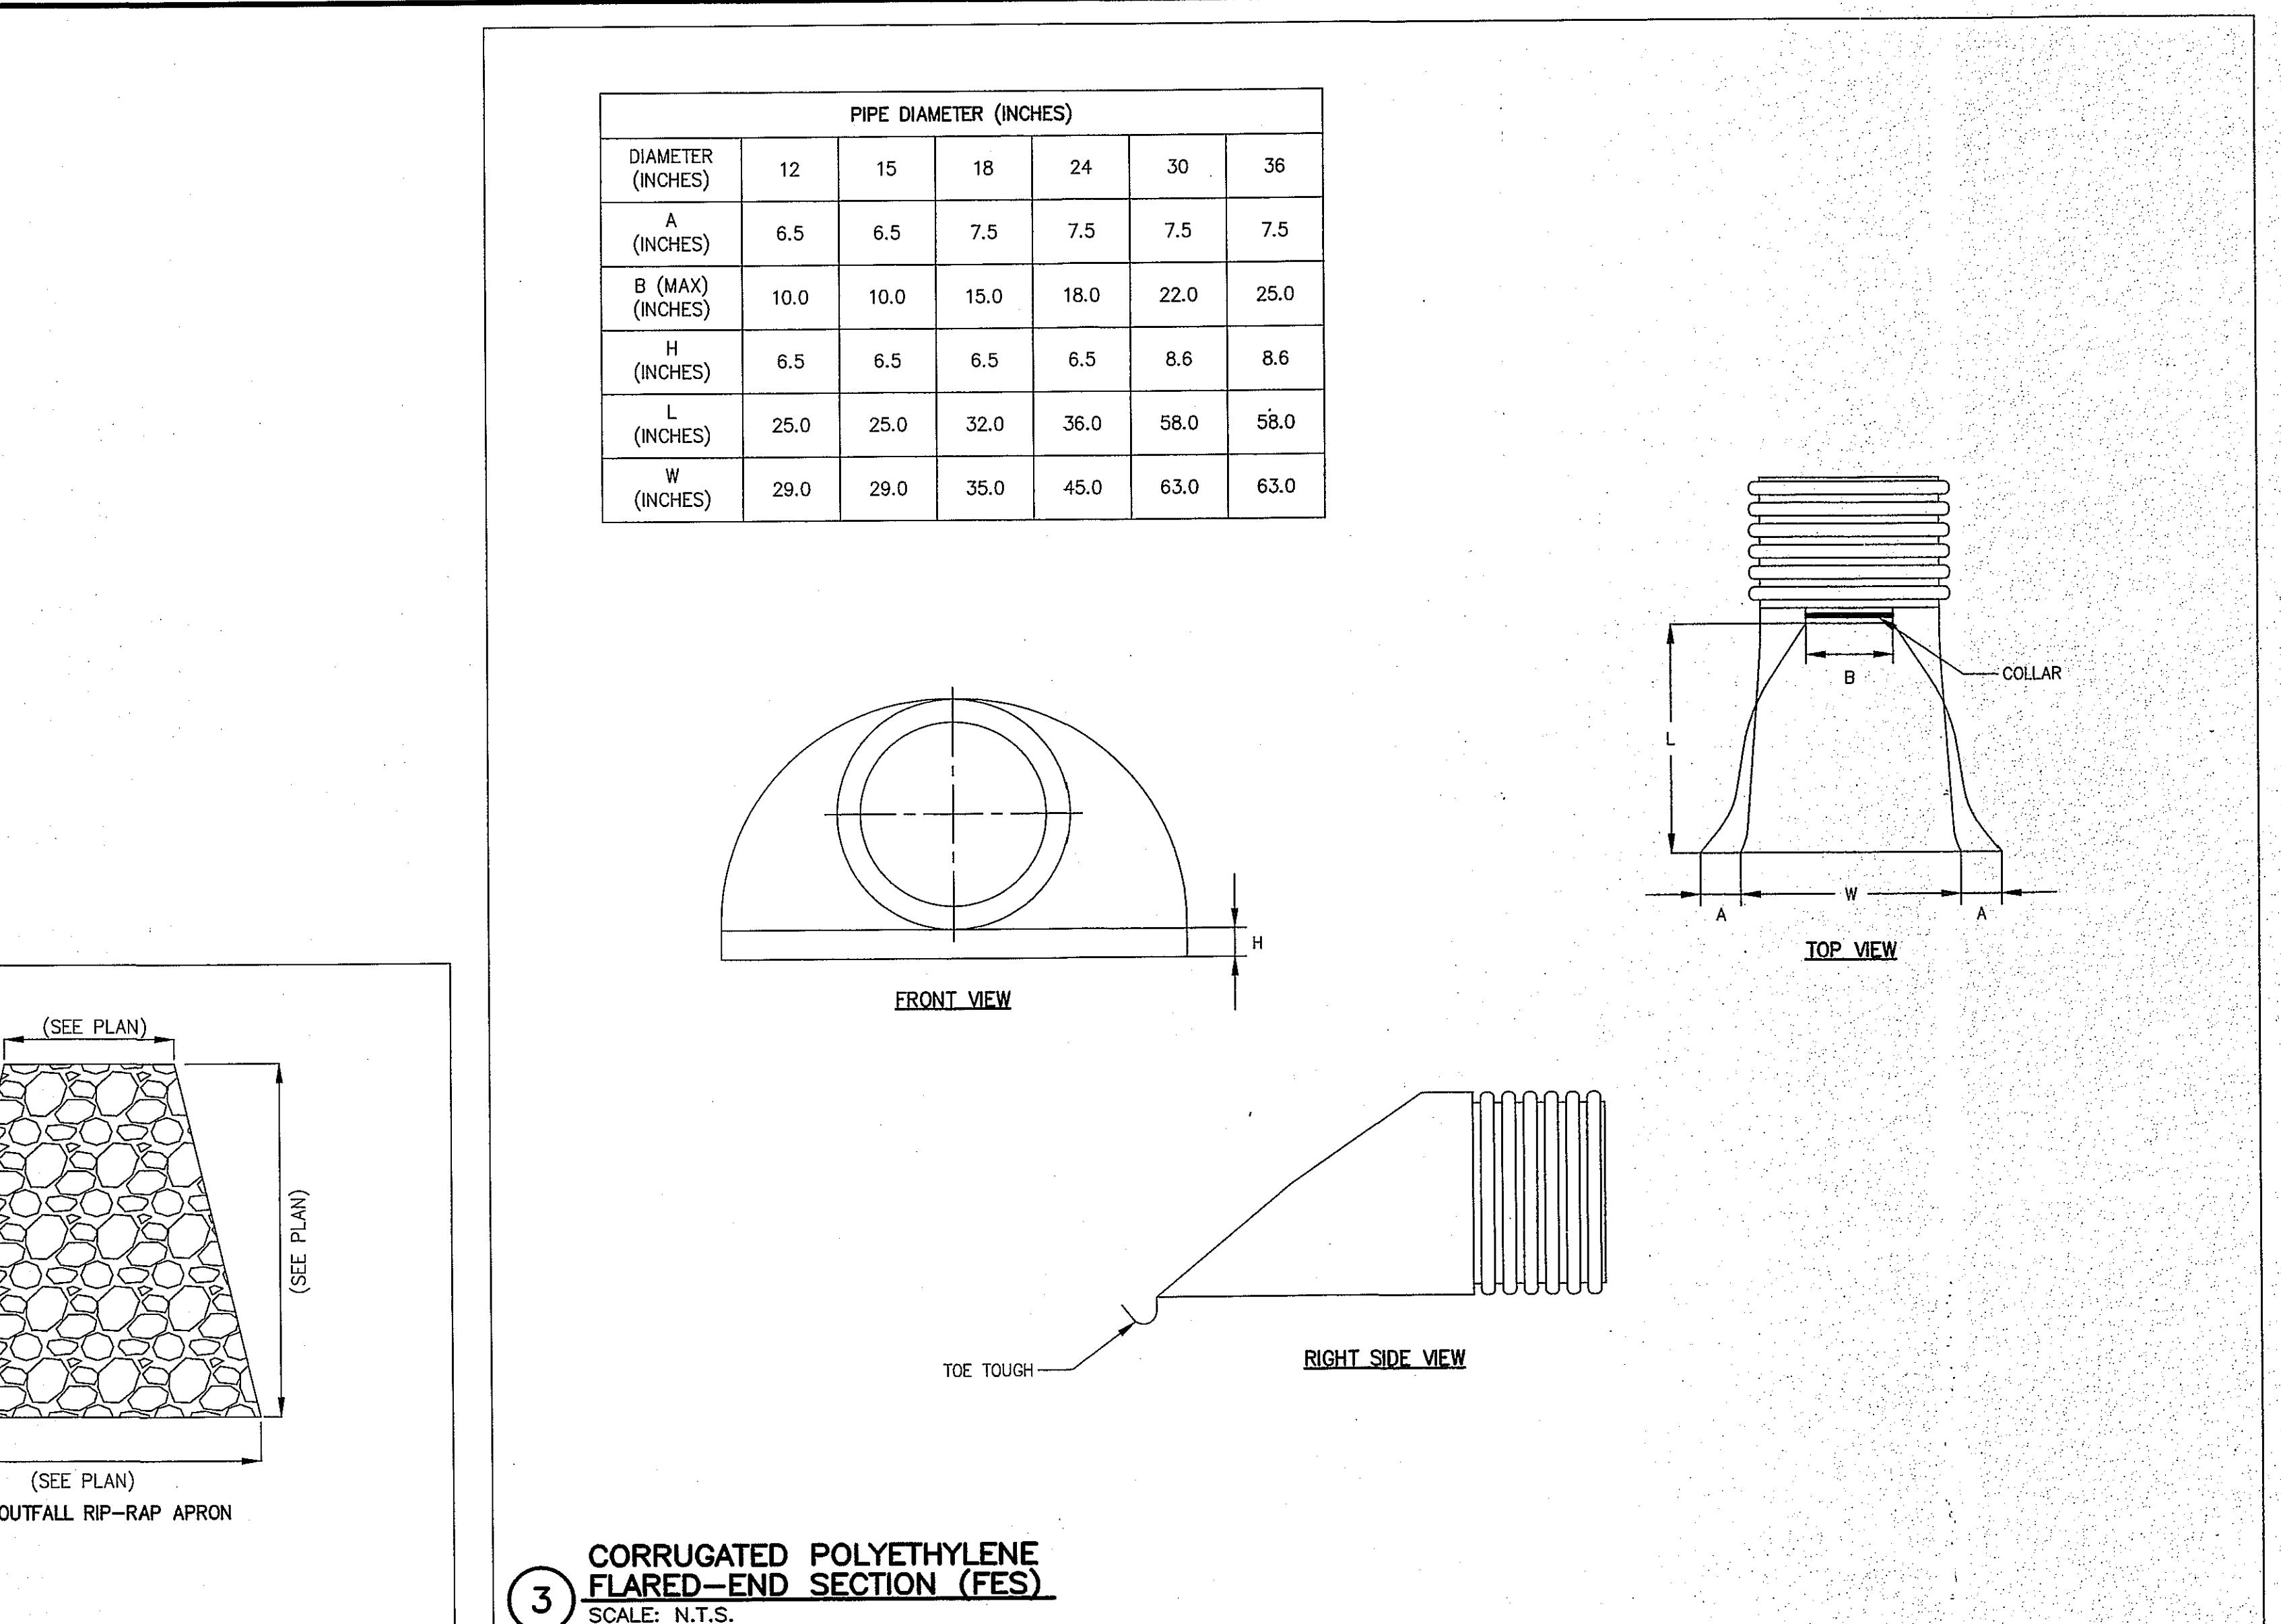
1 SEDIMENT FOREBAY

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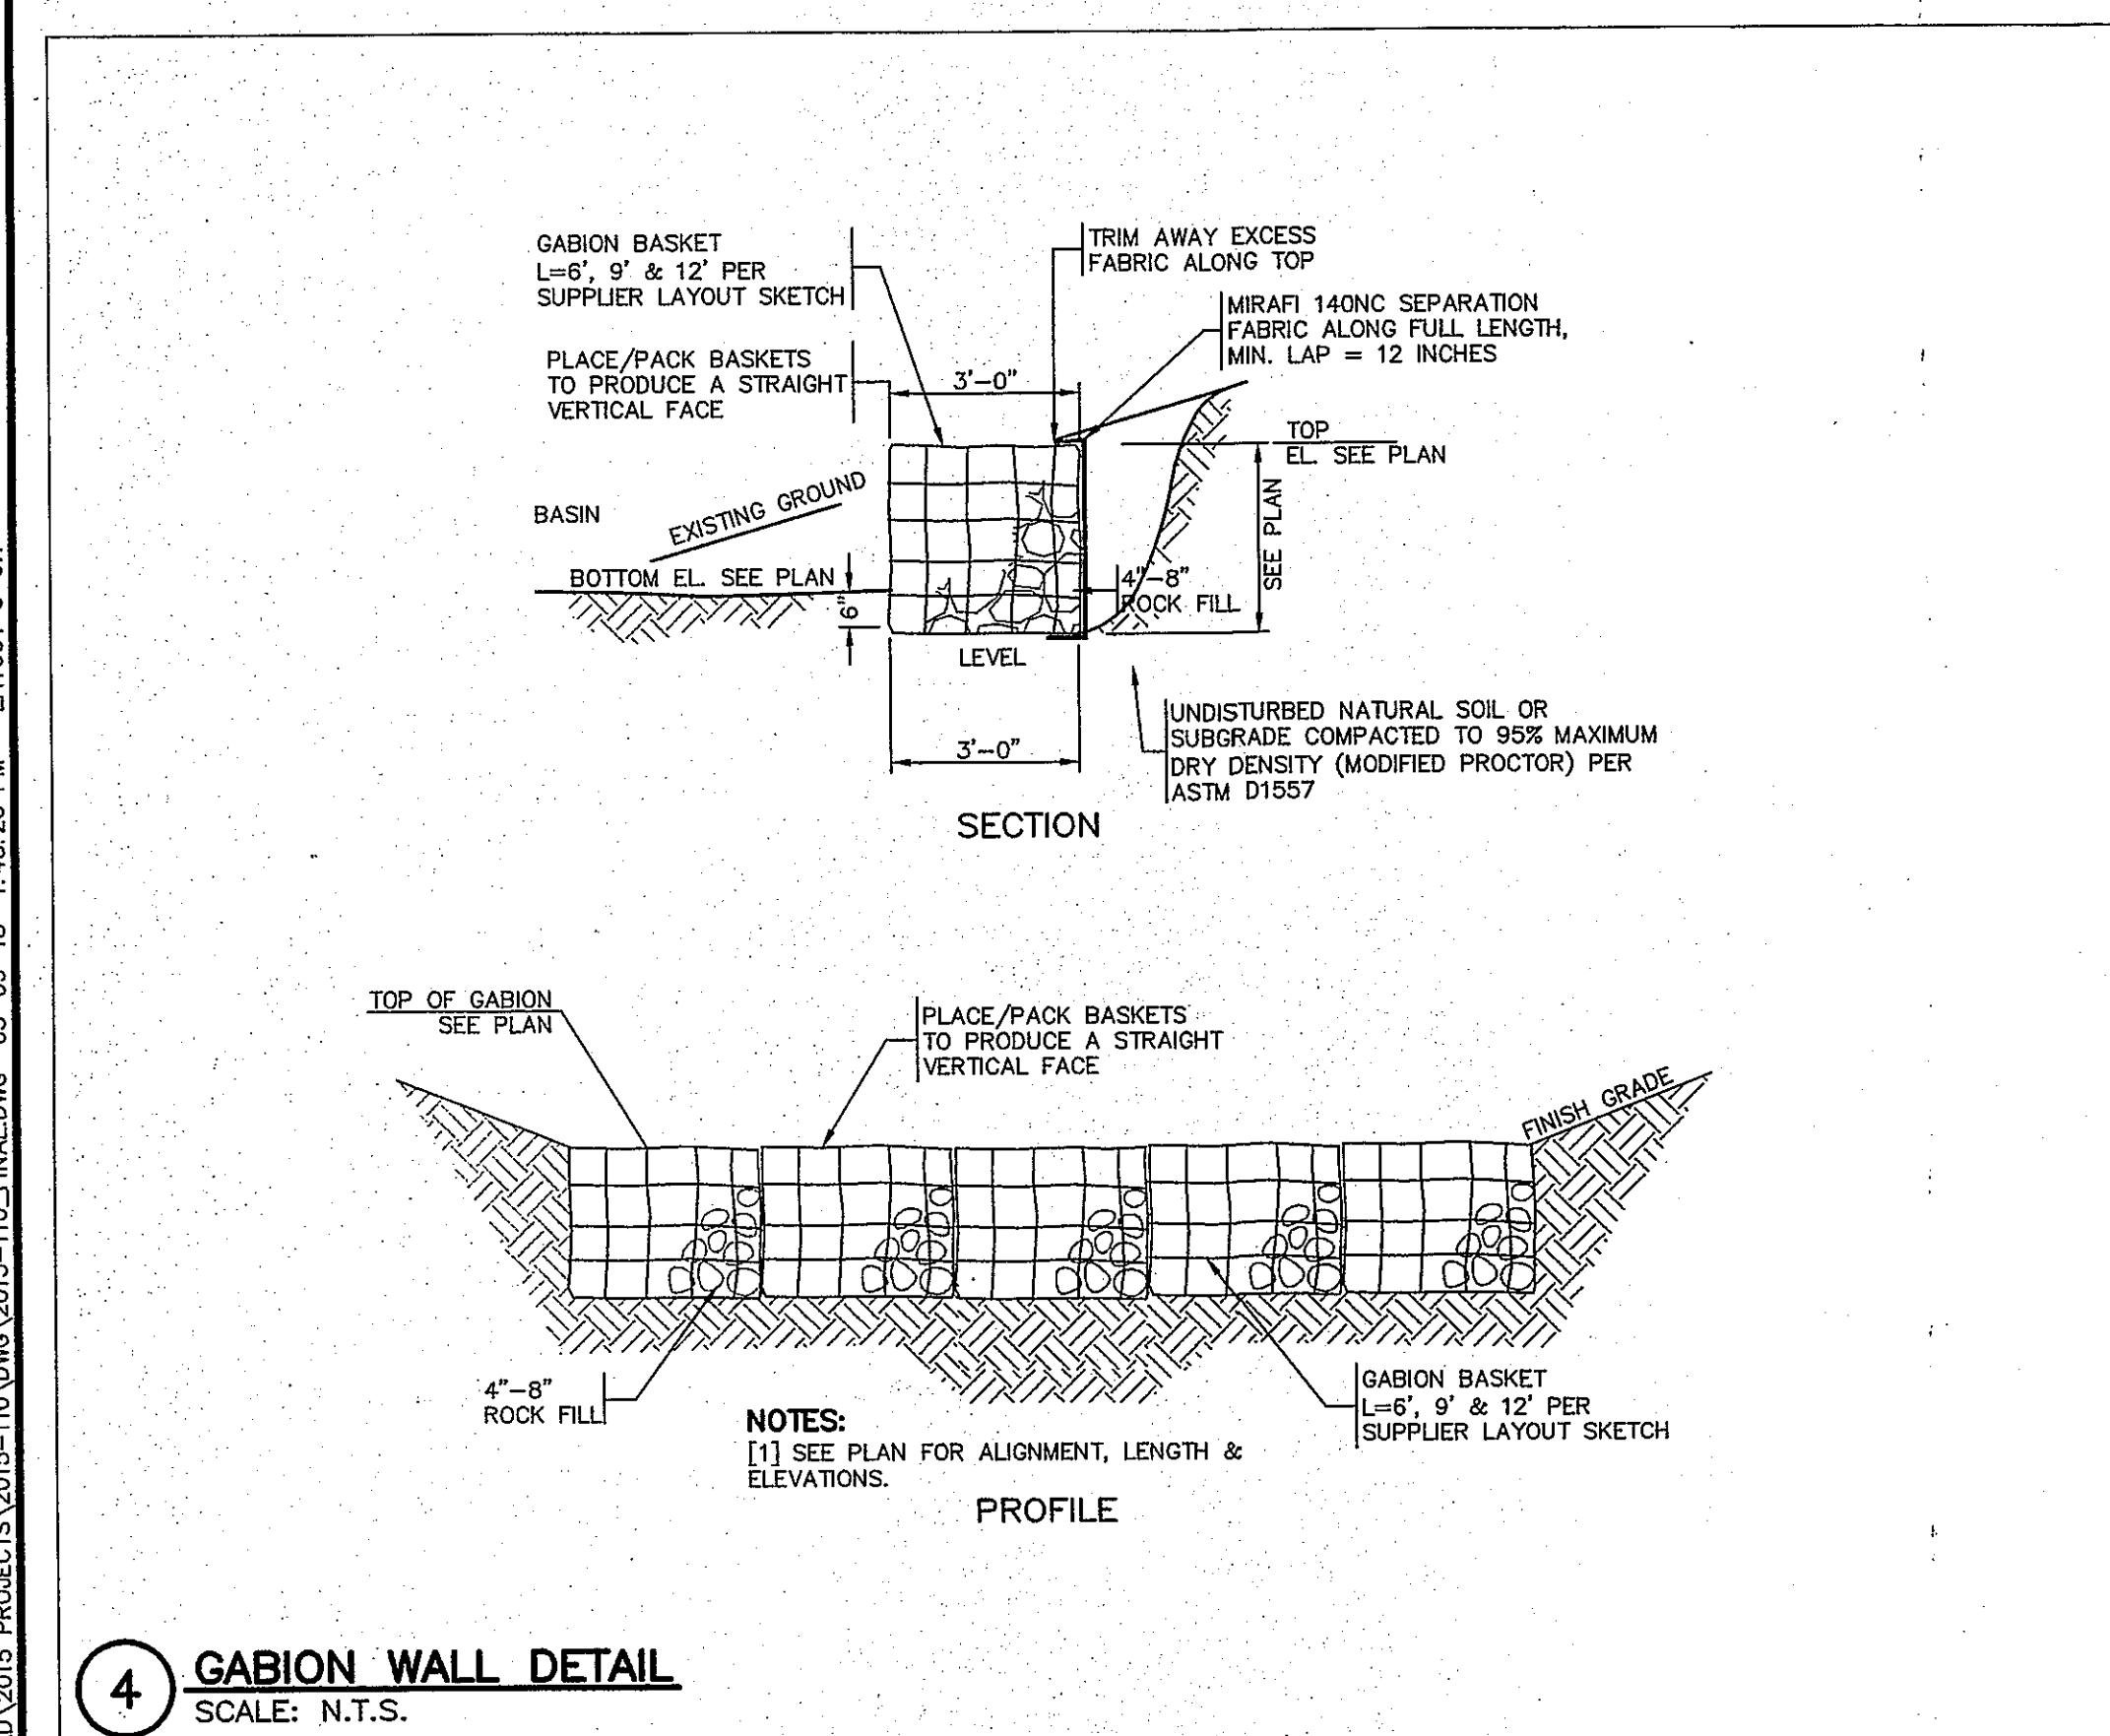
2 STONE RIP-RAP FOR PIPE ENDS

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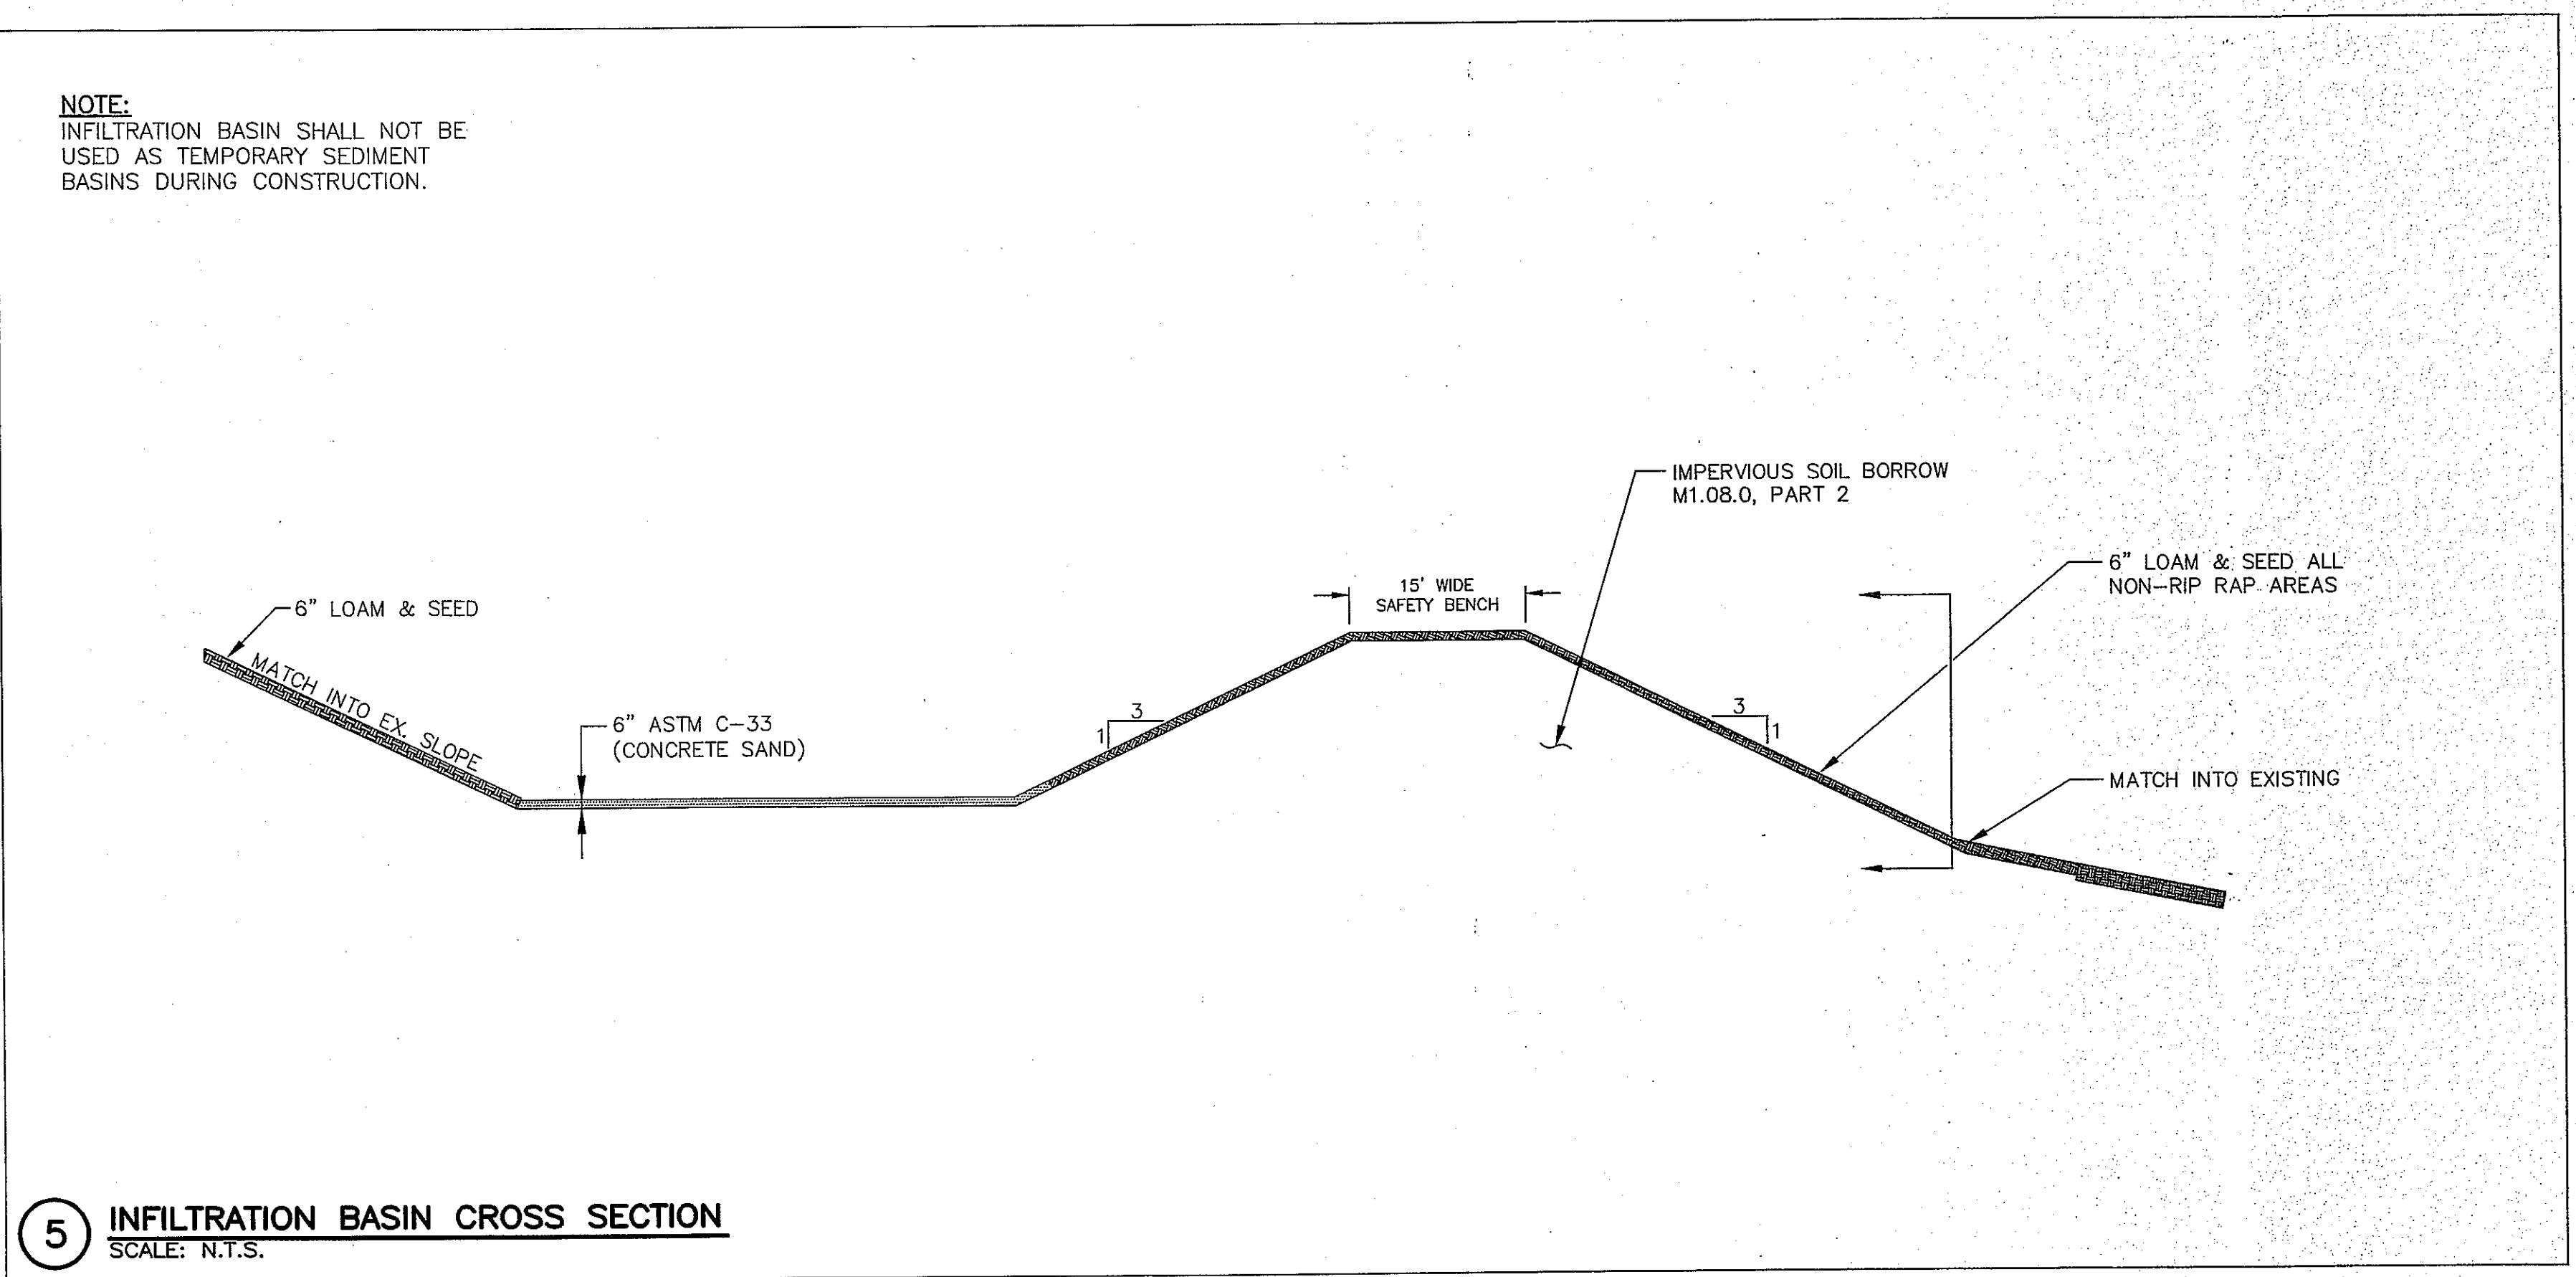
**CORRUGATED POLYETHYLENE
FLARED-END SECTION (FES)**

SCALE: N.T.S.

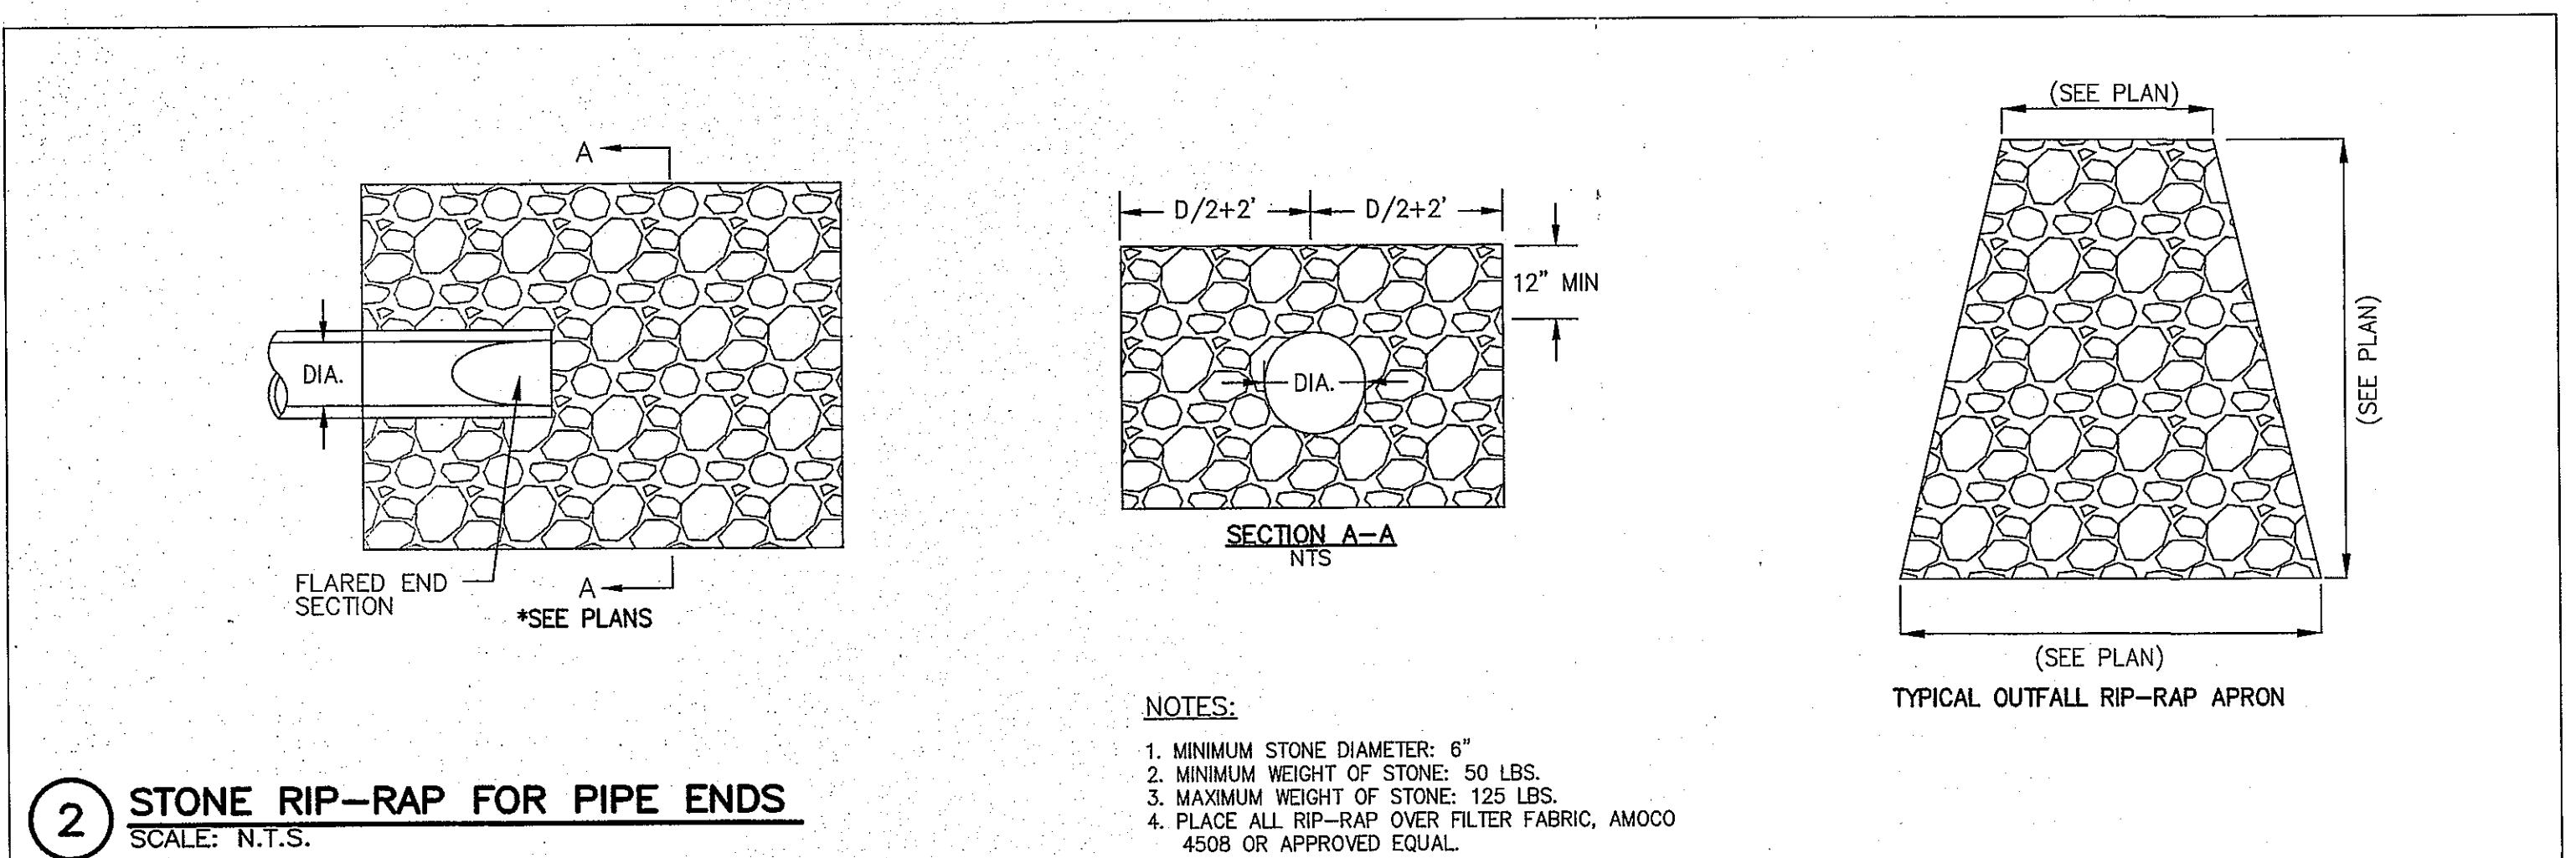


4 GABION WALL DETAIL

SCALE: N.T.S.



5 **INFILTRATION BASIN CROSS SECTION**
SCALE: N.T.S.

3 SCALE: N.T.S.

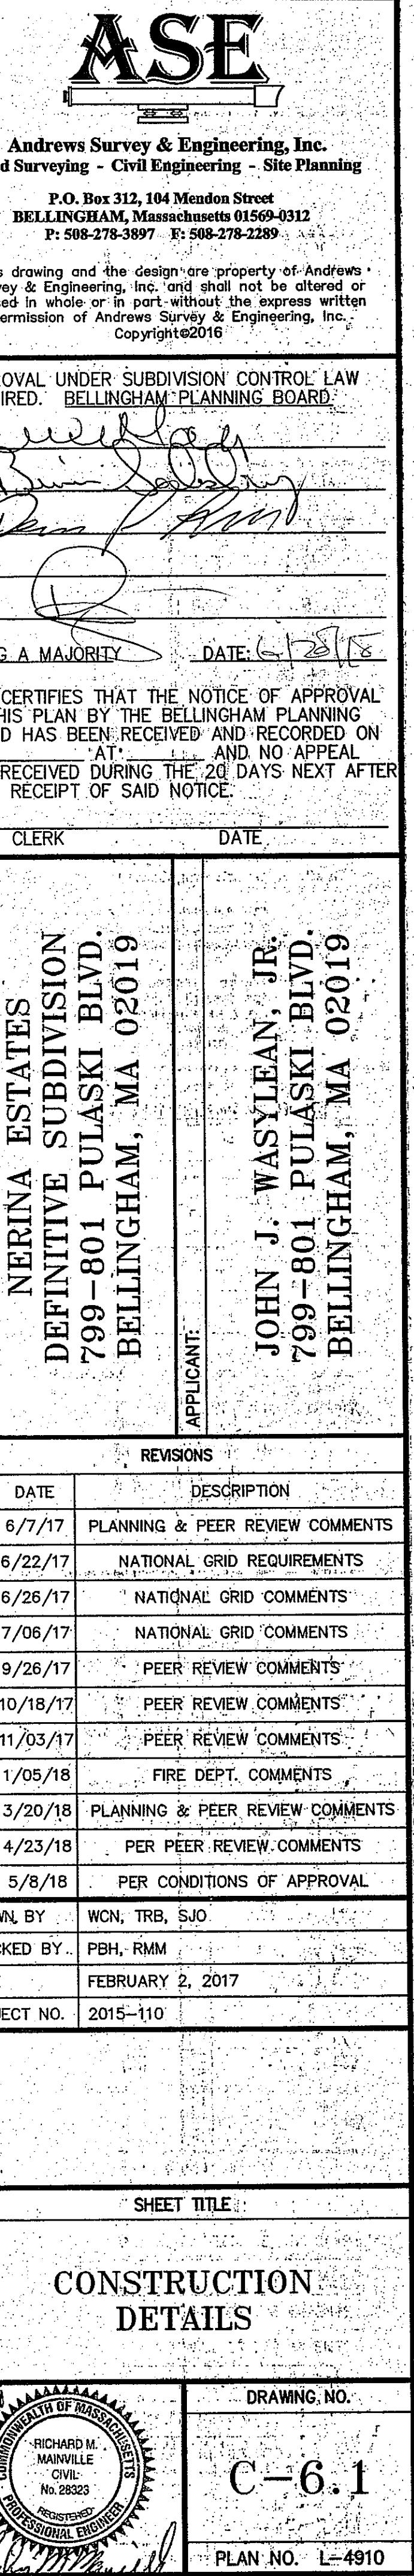



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APPROVAL UNDER SUBDIVISION CONTROL LAW
REQUIRED: BELLINGHAM PLANNING BOARD

BEING A MAJORITY DATE: 1/18/18

THIS CERTIFIES THAT THE NOTICE OF APPROVAL
OF THIS PLAN BY THE BELLINGHAM PLANNING
BOARD HAS BEEN RECEIVED AND RECORDED ON
AT 1/18/18 AND NO APPEAL ON
WAS RECEIVED DURING THE 20 DAYS NEXT AFTER
SUCH RECEIPT OF SAID NOTICE.

TOWN CLERK DATE

PROJECT: NERINA ESTATES
DEFINITIVE SUBDIVISION
799-801 PULASKI BLVD.
BELLINGHAM, MA 02019
APPLICANT: JOHN J. WASYLEAN, JR.
799-801 PULASKI BLVD.
BELLINGHAM, MA 02019

| REVISIONS | | |
|-----------|----------|---------------------------------|
| NO. | DATE | DESCRIPTION |
| 1 | 6/7/17 | PLANNING & PEER REVIEW COMMENTS |
| 2 | 6/22/17 | NATIONAL GRID REQUIREMENTS |
| 3 | 6/26/17 | NATIONAL GRID COMMENTS |
| 4 | 7/06/17 | NATIONAL GRID COMMENTS |
| 5 | 9/26/17 | PEER REVIEW COMMENTS |
| 6 | 10/18/17 | PEER REVIEW COMMENTS |
| 7 | 11/03/17 | PEER REVIEW COMMENTS |
| 8 | 1/05/18 | FIRE DEPT. COMMENTS |
| 9 | 3/20/18 | PLANNING & PEER REVIEW COMMENTS |
| 10 | 4/23/18 | PER PEER REVIEW COMMENTS |
| 11 | 5/8/18 | PER CONDITIONS OF APPROVAL |


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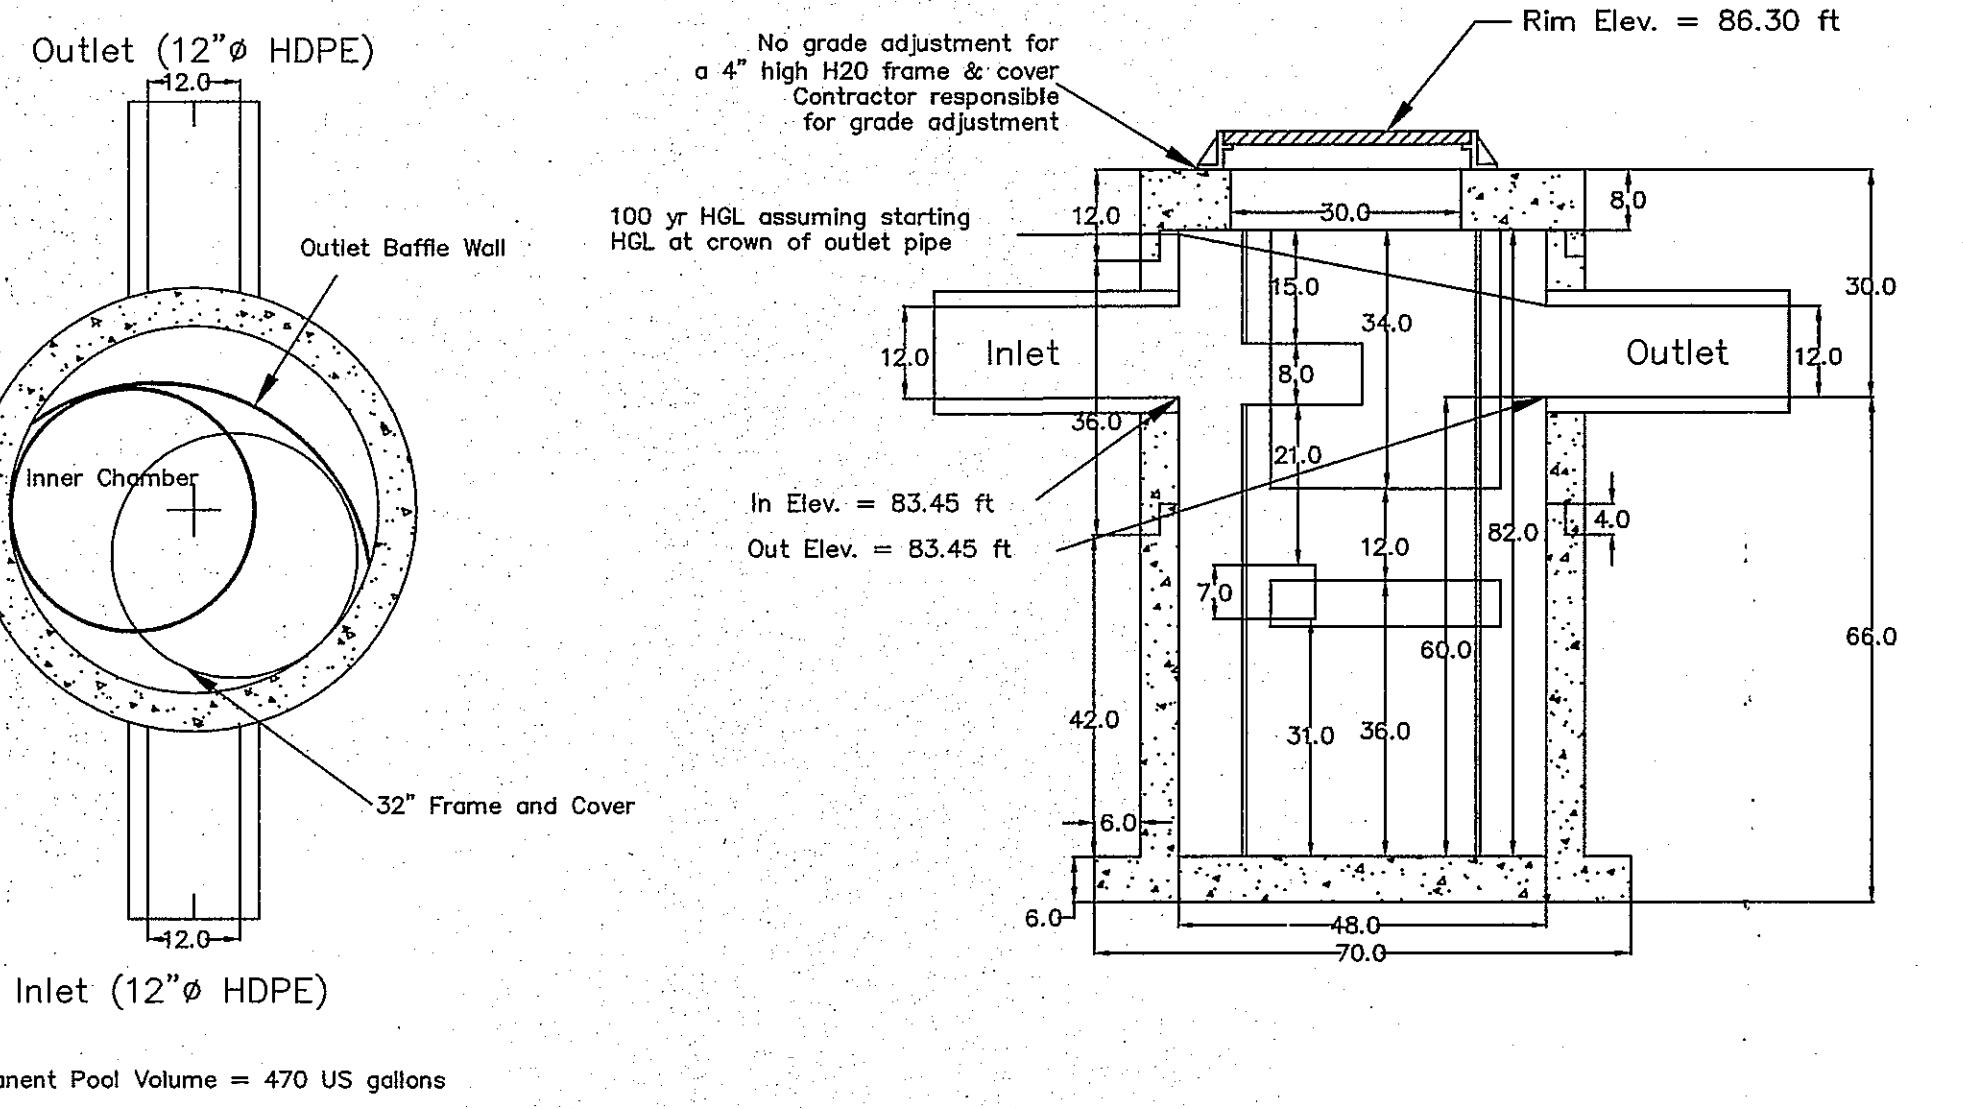
CHECKED BY: PBH, RMM.

DATE: FEBRUARY 2, 2017

PROJECT NO.: 2015-110

SHEET TITLE: CONSTRUCTION DETAILS

DRAWING NO.: C-6.2
PLAN NO.: L-4910

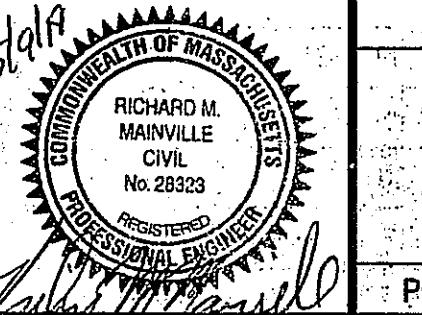
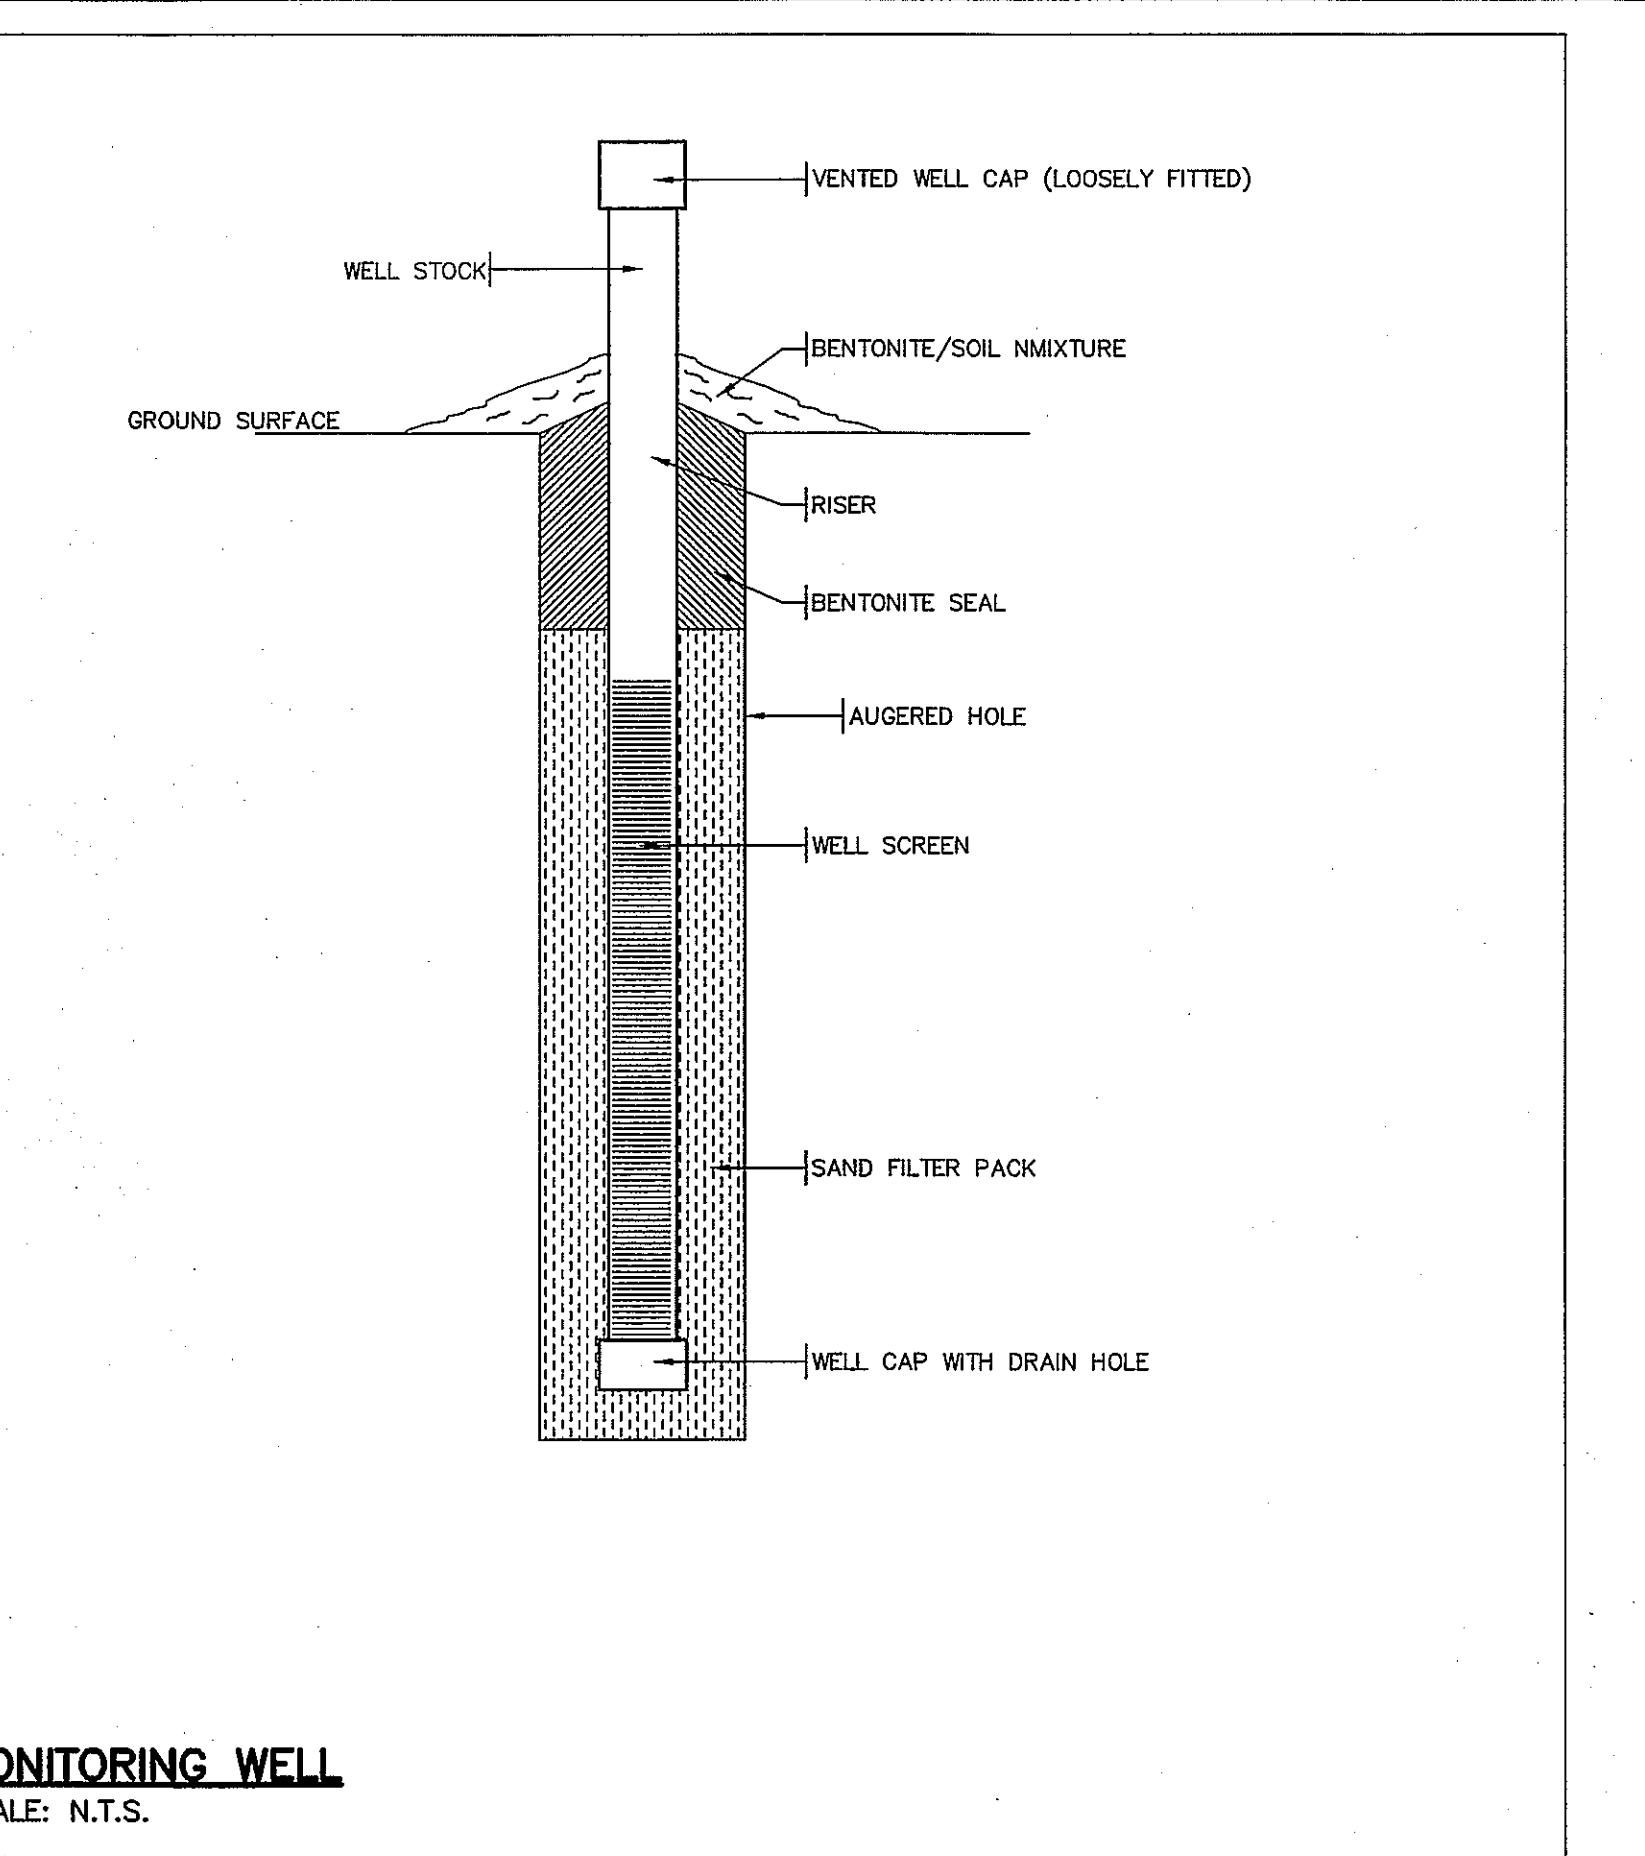


U.S. Patent No. 6,951,619


Hydroworks, LLC


1 HYDROWORKS HG4 (48"Ø)

SCALE: N.T.S.



2 MONITORING WELL

SCALE: N.T.S.

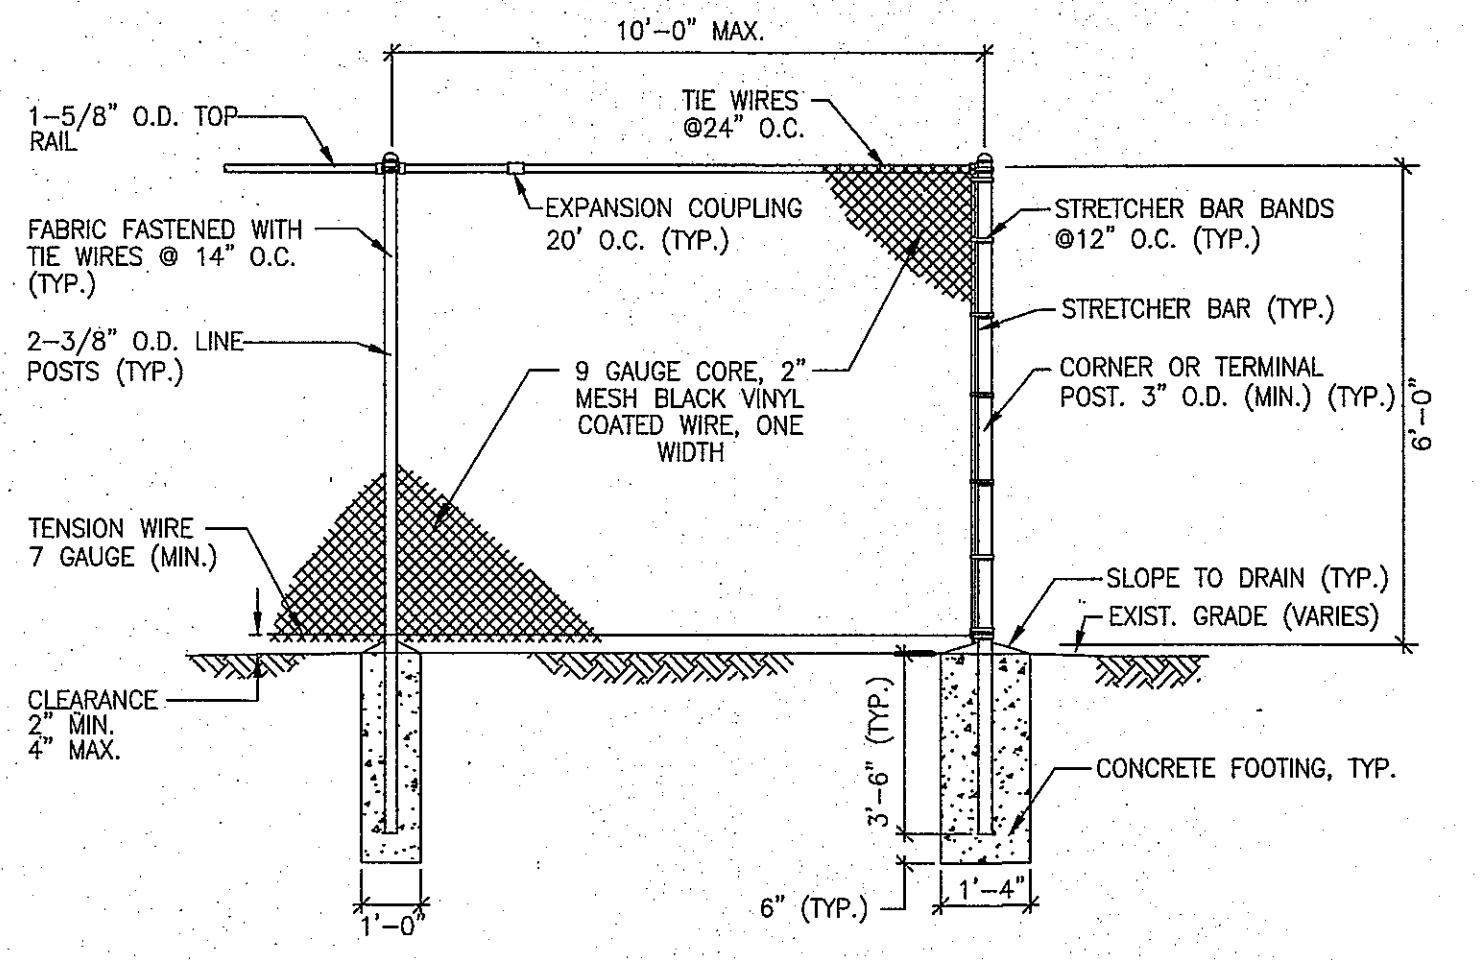

3 CHAIN LINK FENCE (CLF)

SCALE: N.T.S.

