

Appeal

BELLINGHAM ZONING BOARD

10 MECHANIC STREET BELLINGHAM, MASSACHUSETTS 02019 (508) 657-2893 ZoningBoard@bellinghamma.org

Variance

SPECIFY TYPE OF APPLICATION (circle)

Special Permit

| APPEAL OF BUILDING INSPECTORS DECISION: | | | | | |
|---|--|----------------------------|--|--|--|
| ■ Please attach a copy | of the Building Inspector's | letter/decision. | | | |
| SPECIAL PERMIT Principal Use | : (check all that apply) • Non-Conforming Situation | ■ Flood Plain | | | |
| Accessory Use | ■ Home Occupation | ■ Comprehensive Permit | | | |
| ■ Multi-Family Housing | ■ Earth Removal | ■ Family Apartment □ Other | | | |
| VARIANCE: (check Rear Yard Setback | all that apply) • Area | ■Lot Width | | | |
| ■Side Yard Setback | ■Lot Frontage | ■Percent Area Building | | | |
| ■Front Yard Setback | | | | | |
| Signature Emailbmartinelli@ | | | | | |
| Property Owner: Signature American Tower - See LOA Email Address_ 236 Maple St., Bellingham, MA | | | | | |
| Address of Subject Pr | Address of Subject Premises 236 Maple Street | | | | |
| If no address, descript property | tion of | | | | |



BELLINGHAM ZONING BOARD


10 MECHANIC STREET BELLINGHAM, MASSACHUSETTS 02019 (508) 657-2893 ZoningBoard@bellinghamma.org

| Dimensions of Lot: | |
|--|---|
| Frontage: 300 Depth: 669 | |
| Area: 2.47 acres Lot Width: 250 | |
| Zoning District(s) subject premises located: | Suburban |
| Assessor's Map: 37 Lot: 5 | |
| Describe proposed activity: | |
| | op of 142.5' with a new antenna mount and up to he existing 10'x12' concrete pad. |
| Are there any buildings on the premises (if so | o, please describe them including their |
| <u>dimension</u>)?1 Story warehouse and what appears to be a la | orga shad/born |
| 1 Story warehouse and what appears to be a ra | arge sned/ barn. |
| | |
| Describe the subject premises (terrain, septic | system, description of area, etc.) |
| Flat terrain with piles of dirt and mulch for bus | siness. |
| | |
| How long have you owned the subject premis | ses? |
| What is the present use of the subject premis | |
| Mulch and landscaping supply. Cell tower is | |
| 1 0 11 V | : |
| State grounds for the Special Permit/Variance | |
| Relief is appropriate because this cell tower is | pre existing and approved by the municipality and |
| co-location is preferred rather than building a r | |
| I attest that I, to the best of my knowledge have | paid any and all real estate taxes, excise taxes, |
| license and/or permit fees. | |
| Owner: See LOA | |
| Signature See Bon | Date |
| ~.g | |
| Applicant: Brian Martinelli | |
| Applicant: Brian Martinelli Signature Brian Martinelli | Date 11/3/22 |
| | |
| Effective 8/2017 | Please note: This application cannot be processed |
| | Trease note. This application cannot be processed |

unless initialed by the Town Collector:

Town Collector:

Date:

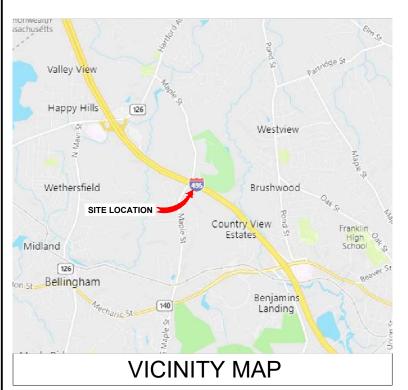

CURRENT PROJECTS:

LTE Only 1C - PACE #: MRCTB048320 LTE 5C - PACE #: MRCTB048786 LTE 4C - PACE #: MRCTB048787 5G NR 1DR-1 - PACE #: MRCTB048788 LTE 2C - PACE #: MRCTB048781



AMERICAN TOWER®

ATC SITE NAME: RJ COBB ATC SITE NUMBER: 91567

AT&T PACE NUMBER: MRCTB048320, MRCTB048786,

MRCTB048787, MRCTB048788, MRCTB048781

AT&T SITE ID: MA1833 AT&T FA CODE:15336751

AT&T SITE NAME: BELLINGHAM MAPLE STREET

SITE ADDRESS: 236 MAPLE STREET

BELLINGHAM, MA 02019-3019

AT&T MOBILITY COLOCATION PLAN



LOCATION MAP

COMPLIANCE CODE PROJECT SUMMARY PROJECT DESCRIPTION SHEET INDEX ALL WORK SHALL BE PERFORMED AND MATERIALS INSTALLED SITE ADDRESS: SHEET NO DESCRIPTION REV DATE BY: IN ACCORDANCE WITH THE CURRENT EDITIONS OF THE THE PROPOSED PROJECT INCLUDES INSTALLING EQUIPMENT 236 MAPLE STREET FOLLOWING CODES AS ADOPTED BY THE LOCAL G-001 TITLE SHEET 09/16/22 DGD CABINETS IN A PROPOSED WIC SHELTER INSIDE A 10' X 20' GROUND GOVERNMENT AUTHORITIES. NOTHING IN THESE PLANS IS TO BELLINGHAM, MA 02019-3019 G-002 GENERAL NOTES 09/16/22 DGD SPACE, AND INSTALLING NEW EQUIPMENT AND MOUNTS ON THE BE CONSTRUED TO PERMIT WORK NOT CONFORMING TO **EXISTING TOWER** THESE CODES C-001 OVERALL SITE PLAN 09/16/22 DGD COUNTY: NORFOLK 1. 2015 INTERNATIONAL BUILDING CODE (IBC) DETAILED SITE PLAN DGD C-101 09/16/22 **GEOGRAPHIC COORDINATES:** 2. 2018 INTERNATIONAL ENERGY CONSERVATION CODE (IECC) C-102 DETAILED EQUIPMENT LAYOUT 09/16/22 DGD PROPOSED (3) SECTOR FRAMES, (9) ANTENNAS, (9) RRUS, (2) LATITUDE: 42.10234722 3. 2014 NATIONAL ELECTRIC CODE (NEC) SQUIDS, (4) DC CABLES AND (1) FIBER TRUNK TO BE INSTALLED C-201 TOWER ELEVATION DGD 09/16/22 4. LOCAL BUILDING CODE LONGITUDE: -71.44709444 C-401 ANTENNA INFORMATION & SCHEDULE 09/16/22 DGD 5. CITY/COUNTY ORDINANCES GROUND ELEVATION: 212' AMSL CONSTRUCTION DETAILS C-501 09/16/22 DGD PROPOSED WIC SHELTER ON A EXISTING 9'-5" X 12'-3" CONCRETE PAD; 15-0" ICE BRIDGE FROM WIC SHELTER TO EXISTING TOWER TO C-502 CONSTRUCTION DETAILS C-503 CONSTRUCTION DETAILS 09/16/22 DGD C-504 CONSTRUCTION DETAILS 09/16/22 DGD E-101 OVERALL ELECTRICAL LAYOUT 09/16/22 DGD PROJECT TEAM **PROJECT NOTES** ENLARGED ELECTRICAL LAYOUT DGD E-102 09/16/22 TOWER OWNER: E-103 ELECTRICAL ONE-LINE & PANEL SCHEDULE 09/16/22 DGD APPLICANT: 1. THE FACILITY IS UNMANNED 0 E-104 DETAILED GROUNDING LAYOUT 09/16/22 DGD AMERICAN TOWER AT&T MOBILITY A TECHNICIAN WILL VISIT THE SITE APPROXIMATELY ONCE 10 PRESIDENTIAL WAY A MONTH FOR ROUTINE INSPECTION AND MAINTENANCE. GROUNDING DETAILS E-501 WOBURN, MA 01801 E-502 GROUNDING DETAILS 09/16/22 THE PROJECT WILL NOT RESULT IN ANY SIGNIFICANT LAND UTILITY COMPANIES **ENGINEER:** DISTURBANCE OR EFFECT OF STORM WATER DRAINAGE SUPPLEMENTAL POWER COMPANY: MASS ELECTRIC INFINIGY ENGINEERING, PLLC NO SANITARY SEWER, POTABLE WATER OR TRASH R-602 SUPPLEMENTAL PHONE: (800) 322-3223 1033 WATERVLIET SHAKER RD DISPOSAL IS REQUIRED R-603 SUPPLEMENTAL ALBANY, NY 12205 TELEPHONE COMPANY: VERIZON HANDICAP ACCESS IS NOT REQUIRED. R-604 SUPPLEMENTAL PHONE: (800) 919-9900 PROPERTY OWNER: R-605 SUPPLEMENTAL R-606 SUPPLEMENTAL PINNACLE TOWERS INC PROJECT LOCATION DIRECTIONS 236 MAPLE STREET -R-607 SUPPLEMENTAL BELLINGHAM - MA - 02019 R-608 SUPPLEMENTAL SUPPLEMENTAL R-609 495 TO EXIT 18. RTE 126 NORTH TO RIGHT ON MAPLE STREET. DRIVE INTO D&D LANDSCAPING SUPPLY. TOWER WILL BE IN Know what's below. Call before you dig.



INFINIGY8 ENGINEERING, PLLC

1033 WATERVLIET SHAKER RD ALBANY, NY 12205

| REV. | . DESCRIPTION | | DATE |
|------------|------------------|------------|----------|
| <u> </u> | A PRELIM | | 12/30/20 |
| <u>B</u> _ | B PRELIM | | 08/15/22 |
| <u> </u> | PRELIM | RCD | 08/16/22 |
| <u> </u> | PRELIM | <u>DGD</u> | 09/14/22 |
| <u> </u> | FOR CONSTRUCTION | DGD | 09/16/22 |

ATC SITE NUMBER:

91567

ATC SITE NAME:

RJ COBB

AT&T MOBILITY SITE NAME:

BELLINGHAM MAPLE STREET

SITE ADDRESS: 236 MAPLE STREET BELLINGHAM. MA 02019-3019

SEAL:





| - | DATE DRAWN: | 09/16/22 |
|---|--------------|-------------|
| _ | ATC JOB NO: | 13330269_G2 |
| _ | CUSTOMER ID: | MA1833 |
| | CUSTOMER #: | 15336751 |
| | | |

TITLE SHEET

SHEET NUMBER:

G-001

GENERAL CONSTRUCTION NOTES:

- OWNER FURNISHED MATERIALS, AT&T MOBILITY "THE COMPANY" WILL PROVIDE AND THE 22-CONTRACTOR WILL INSTALL
- BTS EQUIPMENT FRAME (PLATFORM) AND ICEBRIDGE SHELTER (GROUND
 - BUILD/CO-LOCATE ONLY)

 B. AC/TELCO INTERFACE BOX (PPC)
 - C. ICE BRIDGE (CABLE TRAY WITH COVER) (GROUND BUILD/CO-LOCATE ONLY, GC TO FURNISH AND INSTALL FOR ROOFTOP INSTALLATION)
- D. TOWERS, MONOPOLES
- E. TOWER LIGHTING
- F. GENERATORS & LIQUID PROPANE TANK
- G. ANTENNA STANDARD BRACKETS, FRAMES AND PIPES FOR MOUNTING
- H. ANTENNAS (INSTALLED BY OTHERS)
- I. TRANSMISSION LINE
- J. TRANSMISSION LINE JUMPERS
- K. TRANSMISSION LINE CONNECTORS WITH WEATHERPROOFING KITS
- L. TRANSMISSION LINE GROUND KITS
- M. HANGERS
- N. HOISTING GRIPS
- O. BTS EQUIPMENT
- 2. THE CONTRACTOR IS RESPONSIBLE TO PROVIDE ALL OTHER MATERIALS FOR THE COMPLETE INSTALLATION OF THE SITE INCLUDING, BUT NOT LIMITED TO, SUCH MATERIALS AS FENCING, STRUCTURAL STEEL SUPPORTING SUB-FRAME FOR PLATFORM, ROOFING LABOR AND MATERIALS, GROUNDING RINGS, GROUNDING WIRES, COPPER-CLAD OR XIT CHEMICAL GROUND ROD(S), BUSS BARS, TRANSFORMERS AND DISCONNECT SWITCHES WHERE APPLICABLE, TEMPORARY ELECTRICAL POWER, CONDUIT, LANDSCAPING COMPOUND STONE, CRANES, CORE DRILLING, SLEEPERS AND RUBBER MATTING, REBAR, CONCRETE CAISSONS, PADS AND/OR AUGER MOUNTS, MISCELLANEOUS FASTENERS, CABLE TRAYS, NON-STANDARD ANTENNA FRAMES AND ALL OTHER MATERIAL AND LABOR REQUIRED TO COMPLETE THE JOB ACCORDING TO THE DRAWINGS AND SPECIFICATIONS. IT IS THE POSITION OF AT&T MOBILITY TO APPLY FOR PERMITTING AND CONTRACTOR RESPONSIBLE FOR PICKUP AND PAYMENT OF REQUIRED PERMITS.
- ALL WORK SHALL CONFORM TO ALL CURRENT APPLICABLE FEDERAL, STATE, AND LOCAL CODES, INCLUDING ANS/JEIA/TIA-222, AND COMPLY WITH ATC CONSTRUCTION SPECIFICATIONS.
- CONTRACTOR SHALL CONTACT LOCAL 811 FOR IDENTIFICATION OF UNDERGROUND UTILITIES PRIOR TO START OF CONSTRUCTION.
- CONTRACTOR SHALL BE RESPONSIBLE FOR COORDINATING ALL REQUIRED INSPECTIONS.
- ALL DIMENSIONS TO, OF, AND ON EXISTING BUILDINGS, DRAINAGE STRUCTURES, AND SITE IMPROVEMENTS SHALL BE VERIFIED IN FIELD BY CONTRACTOR WITH ALL DISCREPANCIES REPORTED TO THE ENGINEER.
- 7. DO NOT CHANGE SIZE OR SPACING OF STRUCTURAL ELEMENTS.
- DETAILS SHOWN ARE TYPICAL; SIMILAR DETAILS APPLY TO SIMILAR CONDITIONS UNLESS
 OTHERWISE NOTED.
 32.
- THESE DRAWINGS DO NOT INCLUDE NECESSARY COMPONENTS FOR CONSTRUCTION SAFETY WHICH SHALL BE THE SOLE RESPONSIBILITY OF THE CONTRACTOR.
- CONTRACTOR SHALL BRACE STRUCTURES UNTIL ALL STRUCTURAL ELEMENTS NEEDED FOR STABILITY ARE INSTALLED. THESE ELEMENTS ARE AS FOLLOWS: LATERAL BRACING, ANCHOR BOLTS. FTC.
- CONTRACTOR SHALL DETERMINE EXACT LOCATION OF EXISTING UTILITIES, GROUNDS DRAINS, DRAIN PIPES, VENTS, ETC. BEFORE COMMENCING WORK.
- 12. INCORRECTLY FABRICATED, DAMAGED, OR OTHERWISE MISFITTING OR NONCONFORMING MATERIALS OR CONDITIONS SHALL BE REPORTED TO THE AT&T MOBILITY REP PRIOR TO REMEDIAL OR CORRECTIVE ACTION. ANY SUCH REMEDIAL ACTION SHALL REQUIRE WRITTEN APPROVAL BY THE AT&T MOBILITY REP PRIOR TO PROCEEDING.
- 13. EACH CONTRACTOR SHALL COOPERATE WITH THE AT&T MOBILITY REP, AND COORDINATE HIS WORK WITH THE WORK OF OTHERS.
- 14. CONTRACTOR SHALL REPAIR ANY DAMAGE CAUSED BY CONSTRUCTION OF THIS PROJECT TO MATCH EXISTING PRE-CONSTRUCTION CONDITIONS TO THE SATISFACTION OF THE AT&T MOBILITY CONSTRUCTION MANAGER
- ALL CABLE/CONDUIT ENTRY/EXIT PORTS SHALL BE WEATHERPROOFED DURING INSTALLATION USING A SILICONE SEALANT.
- WHERE EXISTING CONDITIONS DO NOT MATCH THOSE SHOWN IN THIS PLAN SET, CONTRACTOR SHALL NOTIFY THE AT&T MOBILITY REP AND ENGINEER OF RECORD IMMEDIATELY.
- 17. CONTRACTOR SHALL ENSURE ALL SUBCONTRACTORS ARE PROVIDED WITH A COMPLETE AND CURRENT SET OF DRAWINGS AND SPECIFICATIONS FOR THIS PROJECT.
- 18. CONTRACTOR SHALL REMOVE ALL RUBBISH AND DEBRIS FROM THE SITE AT THE END OF FACH DAY
- CONTRACTOR SHALL COORDINATE WORK SCHEDULE WITH AMERICAN TOWER CORPORATION (ATC) AND TAKE PRECAUTIONS TO MINIMIZE IMPACT AND DISRUPTION OF OTHER OCCUPANTS OF THE FACILITY.
- CONTRACTOR SHALL FURNISH AT&T MOBILITY AND AMERICAN TOWER CORPORATION
 (ATC) WITH A PDF MARKED UP AS-BUILT SET OF DRAWINGS UPON COMPLETION OF
 MACHINE TO THE PROPERTY OF THE PROPE
- PRIOR TO SUBMISSION OF BID, CONTRACTOR SHALL COORDINATE WITH AT&T MOBILITY REP TO DETERMINE WHAT, IF ANY, ITEMS WILL BE PROVIDED. ALL ITEMS NOT PROVIDED SHALL BE PROVIDED AND INSTALLED BY THE CONTRACTOR. CONTRACTOR WILL INSTALL

- ALL ITEMS PROVIDED.
- 22. PRIOR TO SUBMISSION OF BID, CONTRACTOR SHALL COORDINATE WITH AT&T MOBILITY REP TO DETERMINE IF ANY PERMITS WILL BE OBTAINED BY CONTRACTOR. ALL REQUIRED PERMITS NOT OBTAINED BY AT&T MOBILITY MUST BE OBTAINED, AND PAID FOR, BY THE CONTRACTOR.
- 23. CONTRACTOR SHALL INSTALL ALL SITE SIGNAGE IN ACCORDANCE WITH AT&T MOBILITY SPECIFICATIONS AND REQUIREMENTS.
- CONTRACTOR SHALL SUBMIT ALL SHOP DRAWINGS TO AT&T MOBILITY FOR REVIEW AND APPROVAL PRIOR TO FABRICATION.
- 25. ALL EQUIPMENT SHALL BE INSTALLED ACCORDING TO MANUFACTURER'S SPECIFICATIONS AND LOCATED ACCORDING TO AT&T MOBILITY SPECIFICATIONS, AND AS SHOWN IN THESE PLANS.
- 26. THE CONTRACTOR SHALL SUPERVISE AND DIRECT THE PROJECT DESCRIBED HEREIN THE CONTRACTOR SHALL BE SOLELY RESPONSIBLE FOR ALL THE CONSTRUCTION MEANS, METHODS, TECHNIQUES, SEQUENCES AND PROCEDURES AND FOR COORDINATING ALL PORTIONS OF THE WORK INNER THE CONTRACT.
- 27. CONTRACTOR SHALL NOTIFY AT&T MOBILITY REP A MINIMUM OF 48 HOURS IN ADVANCE OF POURING CONCRETE OR BACKFILLING ANY UNDERGROUND UTILITIES, FOUNDATIONS OR SEALING ANY WALL, FLOOR OR ROOF PENETRATIONS FOR ENGINEERING REVIEW
- 28. CONTRACTOR SHALL BE RESPONSIBLE FOR SITE SAFETY INCLUDING COMPLIANCE WITH ALL APPLICABLE OSHA STANDARDS AND RECOMMENDATIONS AND SHALP PROVIDE ALL NECESSARY SAFETY DEVICES INCLUDING PPE AND PPM AND CONSTRUCTION DEVICES SUCH AS WELDING AND FIRE PREVENTION, TEMPORARY SHORING, SCAFFOLDING, TRENCH BOXES/SI, OPING, BARRIERS, ETC.
- 29. THE CONTRACTOR SHALL PROTECT AT HIS OWN EXPENSE, ALL EXISTING FACILITIES AND SUCH OF HIS NEW WORK LIABLE TO INJURY DURING THE CONSTRUCTION PERIOD. ANY DAMAGE CAUSED BY NEGLECT ON THE PART OF THIS CONTRACTOR OR HIS REPRESENTATIVES, OR BY THE ELEMENTS DUE TO NEGLECT ON THE PART OF THIS CONTRACTOR OR HIS REPRESENTATIVES, EITHER TO THE EXISTING WORK, OR TO HIS WORK OR THE WORK OF ANY OTHER CONTRACTOR, SHALL BE REPAIRED AT HIS EXPENSE TO THE OWNER'S SATISFACTION.
- 30. ALL WORK SHALL BE INSTALLED IN A FIRST CLASS, NEAT AND WORKMANLIKE MANNER BY MECHANICS SKILLED IN THE TRADE INVOLVED. THE QUALITY OF WORKMANSHIP SHALL BE SUBJECT TO THE APPROVAL OF THE AT&T MOBILITY REP. ANY WORK FOUND BY THE AT&T MOBILITY REP TO BE OF INFERIOR QUALITY AND/OR WORKMANSHIP SHALL BE REPLACED AND/OR REWORKED AT CONTRACTOR EXPENSE UNTIL APPROVAL IS OBTAINED.
- 31. IN ORDER TO ESTABLISH STANDARDS OF QUALITY AND PERFORMANCE, ALL TYPES OF MATERIALS LISTED HEREINAFTER BY MANUFACTURER'S NAMES AND/OR MANUFACTURER'S CATALOG NUMBER SHALL BE PROVIDED BY THESE MANUFACTURERS AS SPECIFIED
- 32. AT&T MOBILITY FURNISHED EQUIPMENT SHALL BE PICKED-UP AT THE AT&T MOBILITY WAREHOUSE, NO LATER THAN 48HR AFTER BEING NOTIFIED INSURED, STORED, UNCRATE, PROTECTED AND INSTALLED BY THE CONTRACTOR WITH ALL APPURTENANCES REQUIRED TO PLACE THE EQUIPMENT IN OPERATION, READY FOR USE. THE CONTRACTOR SHALL BE RESPONSIBLE FOR THE EQUIPMENT AFTER PICKING IT UP.
- 33. AT&T MOBILITY OR HIS ARCHITECT/ENGINEER RESERVES THE RIGHT TO REJECT ANY EQUIPMENT OR MATERIALS WHICH, IN HIS OWN OPINION ARE NOT IN COMPLIANCE WITH THE CONTRACT DOCUMENTS, EITHER BEFORE OR AFTER INSTALLATION AND THE EQUIPMENT SHALL BE REPLACED WITH EQUIPMENT CONFORMING TO THE REQUIREMENTS OF THE CONTRACT DOCUMENTS BY THE CONTRACTOR AT NO COST TO AT&T MOBILITY OR THEIR ARCHITECT/ENGINEER.

STRUCTURAL STEEL NOTES:

- STRUCTURAL STEEL SHALL CONFORM TO THE LATEST EDITION OF THE
 AISC "SPECIFICATION FOR THE DESIGN, FABRICATION AND ERECTION OF STRUCTURAL
 STEEL FOR PURI DINCS."
- STRUCTURAL STEEL ROLLED SHAPES, PLATES AND BARS SHALL CONFORM TO THE FOLLOWING ASTM DESIGNATIONS:
 - A. ASTM A-572, GRADE 50 ALL W SHAPES, UNLESS NOTED OR A992 OTHERWISE
 - B. ASTM A-36 ALL OTHER ROLLED SHAPES, PLATES AND BARS UNLESS NOTED OTHERWISE.
 - C. ASTM A-500, GRADE B HSS SECTION (SQUARE, RECTANGULAR, AND ROUND)
 - D. ASTM A-325, TYPE SC OR N $\,$ ALL BOLTS FOR CONNECTING STRUCTURAL MEMBERS
 - E. ASTM F-1554 07 ALL ANCHOR BOLTS, UNLESS NOTED OTHERWISE
- ALL EXPOSED STRUCTURAL STEEL MEMBERS SHALL BE HOT-DIPPED GALVANIZED AFTER FABRICATION PER ASTM A123. EXPOSED STEEL HARDWARE AND ANCHOR BOLTS SHALL BE GALVANIZED PER ASTM A153 OR B695.
 ALL EXPOSED STRUCTURAL STEEL MEMBERS SHALL BE HOT-DIPPED GALVANIZED AFTER FABRICATION PER ASTM A153 OR B695.
- ALL FIELD CUT SURFACES, FIELD DRILLED HOLES AND GROUND SURFACES WHERE EXISTING PAINT OR GALVANIZATION REMOVAL WAS REQUIRED SHALL BE REPAIRED WITH (2) BRUSHED COATS OF ZRC GALVILITE COLD GALVANIZING COMPOUND PER ASTM A780 AND MANUFACTURER'S RECOMMENDATIONS.
- DO NOT DRILL HOLES THROUGH STRUCTURAL STEEL MEMBERS EXCEPT AS SHOWN AND DETAILED ON STRUCTURAL DRAWINGS.
- . CONNECTIONS:

- A. ALL WELDING TO BE PERFORMED BY AWS CERTIFIED WELDERS AND CONDUCTED IN ACCORDANCE WITH THE LATEST EDITION OF THE AWS WELDING CODE D1.1.
- B. ALL WELDS SHALL BE INSPECTED VISUALLY, 25% OF WELDS SHALL BE INSPECTED WITH DYE PENETRANT OR MAGNETIC PARTICLE TO MEET THE ACCEPTANCE CRITERIA OF AWS D1.1. REPAIR ALL WELDS AS NECESSARY.
- C. INSPECTION SHALL BE PERFORMED BY AN AWS CERTIFIED WELD INSPECTOR.
- IT IS THE CONTRACTORS RESPONSIBILITY TO PROVIDE BURNING/WELDING PERMITS AS REQUIRED BY LOCAL GOVERNING AUTHORITY AND IF REQUIRED SHALL HAVE FIRE DEPARTMENT DETAIL FOR ANY WELDING ACTIVITY.
- E. ALL ELECTRODES TO BE LOW HYDROGEN, MATCHING FILLER METAL, PER AWS D1.1, UNLESS NOTED OTHERWISE.
- F. MINIMUM WELD SIZE TO BE 0.1875 INCH FILLET WELDS, UNLESS NOTED OTHERWISE
- G. PRIOR TO FIELD WELDING GALVANIZING MATERIAL, CONTRACTOR SHALL GRIND OFF GALVANIZING ½" BEYOND ALL FIELD WELD SURFACES. AFTER WELD AND WELD INSPECTION IS COMPLETE, REPAIR ALL GROUND AND WELDED SURFACES WITH ZRC GALVILITE COLD GALVANIZING COMPOUND PER ASTM A780 AND MANUFACTURERS RECOMMENDATIONS.
- H. THE CONTRACTOR SHALL PROVIDE ADEQUATE SHORING AND/OR BRACING WHERE REQUIRED DURING CONSTRUCTION UNTIL ALL CONNECTIONS ARE COMPLETE.
- I. ANY FIELD CHANGES OR SUBSTITUTIONS SHALL HAVE PRIOR APPROVAL FROM
 THE ENGINEER AND T. MORII E PROJECT MANAGER IN WRITING

SPECIAL CONSTRUCTION ANTENNA INSTALLATION NOTES:

- WORK INCLUDE
 - A. ANTENNA AND COAXIAL CABLES ARE FURNISHED BY AT&T MOBILITY UNDER A SEPARATE CONTRACT. THE CONTRACTOR SHALL ASSIST ANTENNA INSTALLATION CONTRACTOR IN TERMS OD COORDINATION AND SITE ACCESS. ERECTION SUBCONTRACTOR SHALL BE RESPONSIBLE FOR THE PROTECTION OF PERSONNEL AND
 - B. INSTALL ANTENNA AS INDICATE ON DRAWINGS AND AT&T MOBILITY SPECIFICATIONS.
 - C. INSTALL GALVANIZED STEEL ANTENNA MOUNTS AS INDICATED ON DRAWINGS
 - D. INSTALL FURNISHED GALVANIZED STEEL OR ALUMINUM WAVEGUIDE AND PROVIDE PRINTOUT OF THAT TEST.
 - E. CONTRACTOR SHALL PROVIDE FOUR (4) SETS OF SWEEP TESTS USING ANRITZU-PACKARD 8713B RF SCALAR NETWORK ANALYZER. SUBMIT FREQUENCY DOMAIN REFLECTOMETER(FDR) TESTS RESULTS TO THE PROJECT MANAGER. SWEEP TESTS SHALL BE AS PER ATTACHED RFS "MINIMUM FIELD TESTING RECOMMENDED FOR ANTENNA AND HELIAX COAXIAL CABLE SYSTEMS" DATED 10/5/93. TESTING SHALL BE PERFORMED BY AN INDEPENDENT TESTING SERVICE AND BE BOUND AND SUBMITTED WITHIN ONE WEEK OF WORK COMPLETION.
 - F. INSTALL COAXIAL CABLES AND TERMINATING BETWEEN ANTENNAS AND EQUIPMENT PER MANUFACTURER'S RECOMMENDATIONS. WEATHERPROOF ALL CONNECTIONS BETWEEN THE ANTENNA AND EQUIPMENT PER MANUFACTURER'S REQUIREMENTS. TERMINATE ALL COAXIAL CABLE THREE (3) FEET IN EXCESS OF ENTRY PORT LOCATION UNLESS OTHERWISE STATED.
 - G. ANTENNA AND COAXIAL CABLE GROUNDING:
- ALL EXTERIOR #6 GREED GROUND WIRE "DAISY CHAIN" CONNECTIONS ARE TO BE WEATHER SEALED WITH RFS CONNECTORS/SPLICE WEATHERPROOFING KIT #221213 OR FOLIAM
- ALL COAXIAL CABLE GROUNDING KITS ARE TO BE INSTALLED ON STRAIGHT RUNS OF COAXIAL CABLE (NOT WITHIN BENDS)

CONCRETE AND REINFORCING STEEL NOTES:

- DESIGN AND CONSTRUCTION OF ALL CONCRETE ELEMENTS SHALL CONFORM TO THE LATEST EDITIONS OF ALL APPLICABLE CODES INCLUDING: ACI 301 "SPECIFICATIONS FOR STRUCTURAL CONCRETE FOR BUILDINGS", ACI 117 "SPECIFICATIONS FOR TOLERANCES FOR CONCRETE CONSTRUCTION AND MATERIALS", AND ACI 318 "BUILDING CODE REQUIREMENTS FOR REINFORCED CONCRETE."
- MIX DESIGN SHALL BE APPROVED BY AT&T MOBILITY REP PRIOR TO PLACING CONCRETE.
- CONCRETE SHALL BE NORMAL WEIGHT, 6 % AIR ENTRAINED (+/- 1.5%) WITH A SLUMP RANGE OF 3-6" AND HAVE A MINIMUM 28-DAY COMPRESSIVE STRENGTH OF 4000 PSI UNLESS OTHERWISE NOTED.
- 4. THE FOLLOWING MATERIALS SHALL BE USED:

PORTLAND CEMENT: ASTM C150. TYPE 2

REINFORCEMENT: ASTM A185, PLAIN STEEL WELDED WIRE FABRIC REINFORCEMENT BARS: ASTM A615, GRADE 60, DEFORMED

NORMAL WEIGHT AGGREGATE: ASTM C33
WATER: ASTM C 94/C 94W

WELDED WIRE FABRIC: A
ADMIXTURES:

-WATER-REDUCING AGENT: ASTM C 494/C 494M, TYPE A -AIR-ENTERING AGENT: ASTM C 260/C 260M

-SUPERPLASTICIZER: ASTM C494, TYPE F OR TYPE G
-RETARDING: ASTM C 494/C 494M. TYPE B

- 6. MINIMUM CONCRETE COVER FOR REINFORCING STEEL SHALL BE NO LESS THAN 3".
- A 3/4" CHAMFER SHALL BE PROVIDED AT ALL EXPOSED EDGES OF CONCRETE IN ACCORDANCE WITH ACI 301 SECTION 4.2.4, UNLESS NOTED OTHERWISE.
- INSTALLATION OF CONCRETE EXPANSION/WEDGE ANCHOR SHALL BE PER MANUFACTURER'S WRITTEN RECOMMENDED PROCEDURE. THE ANCHOR BOLT, DOWEL OR ROD SHALL CONFORM TO MANUFACTURER'S RECOMMENDATION FOR EMBEDMENT DEPTH OR AS SHOWN ON THE DRAWINGS. NO REBAR SHALL BE CUT WITHOUT PRIOR APPROVAL FROM AN ATC ENGINEER WHEN DRILLING HOLES IN CONCRETE.
- ADMIXTURES SHALL CONFORM TO THE APPROPRIATE ASTM STANDARD AS REFERENCED IN "METHOD 1" OF ACI 301.
- DO NOT WELD OR TACK WELD REINFORCING STEEL.
- ALL DOWELS, ANCHOR BOLTS, EMBEDDED STEEL, ELECTRICAL CONDUITS, PIPE SLEEVES, GROUNDS AND ALL OTHER EMBEDDED ITEMS AND FORMED DETAILS SHALL BE IN PLACE BEFORE START OF CONCRETE PLACEMENT.
- REINFORCEMENT SHALL BE COLD BENT WHENEVER BENDING IS REQUIRED.
- 12. DO NOT PLACE CONCRETE IN WATER, ICE, OR ON FROZEN GROUND.
- FOR COLD-WEATHER (ACI 306) AND HOT-WEATHER (ACI 301M) CONCRETE PLACEMENT, CONFORM TO APPLICABLE ACI CODES AND RECOMMENDATIONS. IN EITHER CASE, MATERIALS CONTAINING CHLORIDE, CALCIUM, SALTS, ETC. SHALL NOT BE USED. PROTECT FRESH CONCRETE FROM WEATHER FOR 7 DAYS, MINIMUM.
- 14. ALL CONCRETE SHALL HAVE A "SMOOTH FORM FINISH."
- 15. SPLICING OF REINFORCEMENT IS PERMITTED ONLY AT LOCATIONS SHOWN IN THE CONTRACT DRAWINGS OR AS ACCEPTED BY THE ENGINEER. UNLESS OTHERWISE SHOWN OR NOTED REINFORCING STEEL SHALL BE SPLICED TO DEVELOP ITS FULL TENSILE CAPACITY (CLASS A) IN ACCORDANCE WITH ACI 318.
- 16. DETAILING OF REINFORCING STEEL SHALL CONFORM TO "ACI MANUAL OF STANDARD PRACTICE FOR DETAILING REINFORCED CONCRETE STRUCTURES" (ACI 315).
- 17. ALL SLAB CONSTRUCTION SHALL BE CAST MONOLITHICALLY WITHOUT HORIZONTAL CONSTRUCTION JOINTS. UNLESS SHOWN IN THE CONTRACT DRAWINGS.
- 18. LOCATION OF ALL CONSTRUCTION JOINTS ARE SUBJECT TO THE REQUIREMENTS OF THE CONTRACT DOCUMENTS, CONFORMANCE WITH ACI 318, AND ACCEPTANCE OF THE ENGINEER. DRAWINGS SHOWING LOCATION OF DETAILS OF THE PROPOSED CONSTRUCTION JOINTS SHALL BE SUBMITTED WITH REINFORCING STEEL PLACEMENT DRAWINGS.
- SPLICES OF WWF, AT ALL SPLICED EDGES, SHALL BE SUCH THAT THE OVERLAP MEASURED BETWEEN OUTERMOST CROSS WIRES OF EACH FABRIC SHEET IS NOT LESS THAN THE SPACING OF THE CROSS WIRE PLUS 2 INCHES. NOR LESS THAN 67.
- BAR SUPPORTS SHALL BE ALL-GALVANIZED METAL WITH PLASTIC TIPS.
- M. ALL REINFORCEMENT SHALL BE SECURELY TIED IN PLACE TO PREVENT DISPLACEMENT BY CONSTRUCTION TRAFFIC OR CONCRETE. TIE WIRE SHALL BE OF SUFFICIENT STRENGTH FOR INTENDED PURPOSE, BUT NOT LESS THAN NO. 18 GAUGE.
- SLAB ON GROUND: COMPACT STRUCTURAL FILL TO 95% DENSITY AND THEN PLACE 6" GRAVEL BENEATH SLAB.

ELECTRICAL NOTES:

- ELECTRICAL DESIGN SHALL BE PERFORMED BY ELECTRICAL CONTRACTOR.
 STRUCTURAL DESIGN SHALL BE PERFORMED BY GENERAL CONTRACTOR. ELECTRICAL
 CONTRACTOR SHALL ENSURE THAT ALL WORK COMPLIES WITH ALL APPLICABLE LOCAL
 AND STATE CODES AND NATIONAL ELECTRICAL CODE.
- 2. ALL SUGGESTED ELECTRICAL ELEMENTS (SUCH AS BREAKER SIZES, WIRE SIZES, CONDUITS SIZES ARE FOR ZONING PURPOSES ONLY. IT IS THE RESPONSIBILITY TO OF THE ELECTRICAL CONTRACTOR TO CONFIRM COMPLIANCE WITH LOCAL ELECTRICAL CODES AND PASS ALL APPLICABLE AND NECESSARY INSPECTIONS. IN SOME EVENTS, IT MAY BE NECESSARY TO PERFORM AN ELECTRICAL LOAD STUDY TO VERIFY THE CAPACITY OF THE EXISTING SERVICE. THIS IS NOT THE RESPONSIBILITY OF CONCORDIA. IT IS THE RESPONSIBILITY OF THE ELECTRICAL CONTRACTOR.
- CONTRACTOR SHALL FIELD LOCATE ALL BELOW GRADE GROUND LINES AND UTILITY LINES PRIOR TO CONSTRUCTION. CONTRACTOR IS RESPONSIBLE FOR RELOCATION OF ALL UTILITIES AND GROUND LINES THAT MAY BECOME DISTURBED OR CONFLICTING IN THE COURSE OF CONSTRUCTION.

ALL DISCREPANCIES FROM WHAT IS SHOWN ON THESE CONSTRUCTION DRAWINGS SHALL BE COMMUNICATED TO INFINIGY ENGINEERING IMMEDIATELY FOR CORRECTION OR RE-DESIGN. FAILURE TO COMMUNICATE DIRECTLY WITH INFINIGY ENGINEERING OR ANY CHANGES FROM THE DESIGN CONDUCTED WITHOUT PRIOR APPROVAL FROM INFINIGY ENGINEERING SHALL BE THE SOLE RESPONSIBILITY OF THE GENERAL CONTRACTOR.



INFINIGY ENGINEERING, PLLC

ALBANY, NY 12205

 REV.
 DESCRIPTION
 BY
 DATE

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 PRELIM
 DB
 12/30/20

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 08/15/22

 C
 PRELIM
 RCD
 08/16/22

 D
 PRELIM
 DGD
 09/14/22

 O
 FOR CONSTRUCTION
 DGD
 09/16/22

ATC SITE NUMBER

91567

ATC SITE NAME:

RJ COBB

AT&T MOBILITY SITE NAME:

BELLINGHAM MAPLE STREET

SITE ADDRESS: 236 MAPLE STREET BELLINGHAM. MA 02019-3019

SEAL:






| DATE DRAWN: | 09/16/22 |
|--------------|-------------|
| ATC JOB NO: | 13330269_G2 |
| CUSTOMER ID: | MA1833 |
| CUSTOMER #: | 15336751 |
| | |

GENERAL NOTES

SHEET NUMBER

G-002

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1033 WATERVLIET SHAKER RD ALBANY, NY 12205
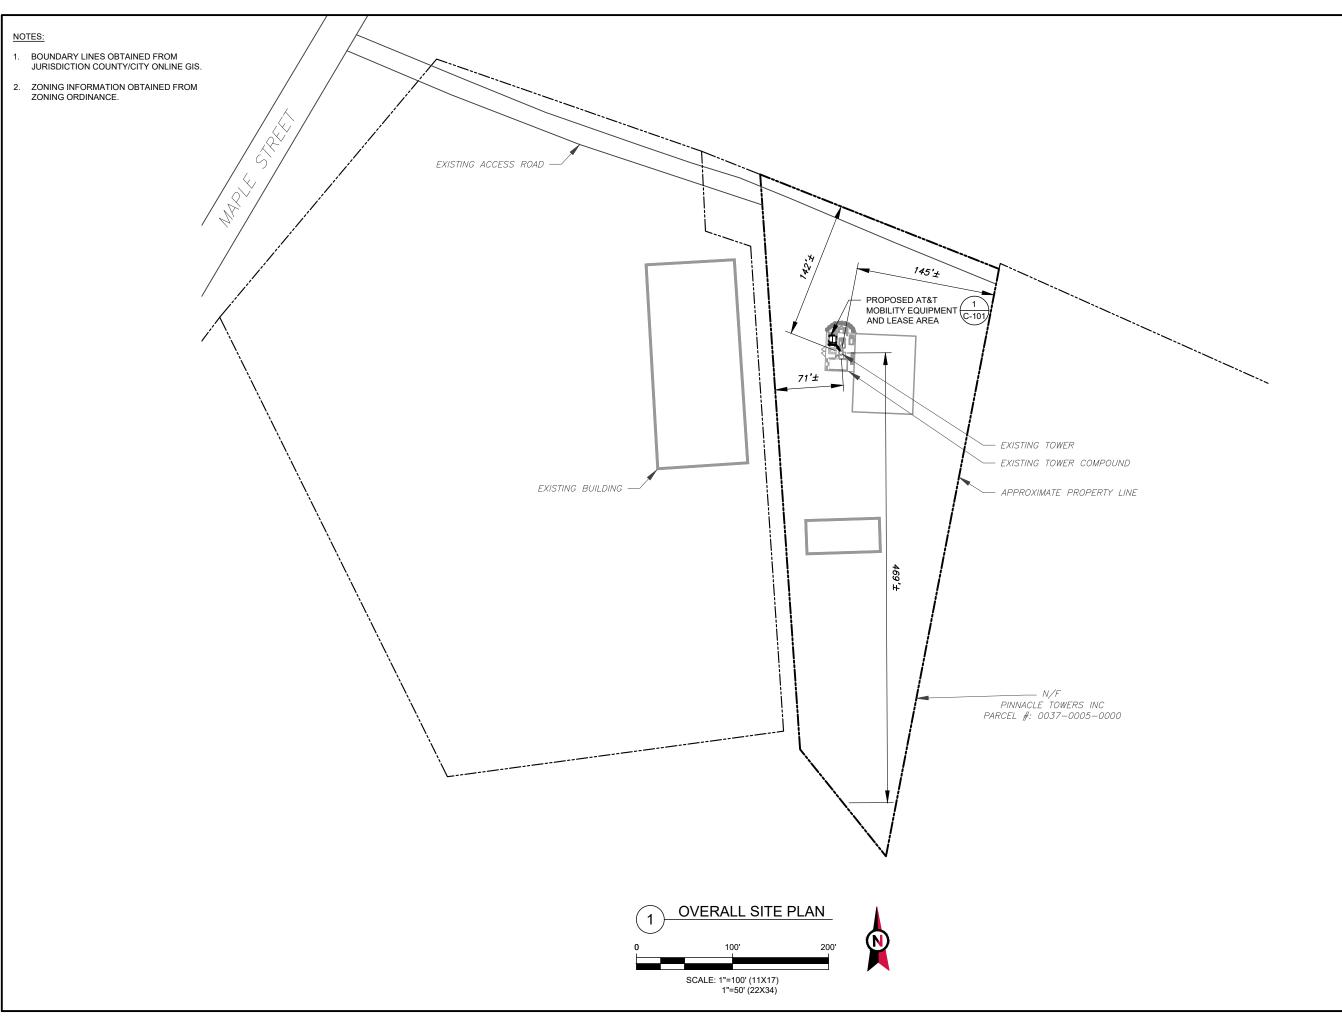
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|------------|------------------|------------|----------|
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| | CUSTOMER ID: | MA1833 |
| | CUSTOMER #: | 15336751 |
| | | |

OVERALL SITE PLAN

SHEET NUMBER:

REVISION:

C-001

SITE PLAN NOTES:

TRN


- 1. THIS SITE PLAN REPRESENTS THE BEST PRESENT KNOWLEDGE AVAILABLE TO THE ENGINEER AT THE TIME OF THIS DESIGN. THE CONTRACTOR SHALL VISIT THE SITE PRIOR TO CONSTRUCTION AND VERIFY ALL EXISTING CONDITIONS RELATED TO THE SCOPE OF WORK FOR THIS PROJECT.
- 2. ICE BRIDGE, CABLE LADDER, COAX PORT, AND COAX CABLE ARE SHOWN FOR REFERENCE ONLY. CONTRACTOR SHALL CONFIRM THE EXACT LOCATION OF ALL PROPOSED AND EXISTING EQUIPMENT AND STRUCTURES DEPICTED ON THIS PLAN. BEFORE UTILIZING EXISTING CABLE SUPPORTS, COAX PORTS, INSTALLING NEW PORTS OR ANY OTHER EQUIPMENT, CONTRACTOR SHALL VERIFY ALL ASPECTS OF THE COMPONENTS MEET THE ATC SPECIFICATIONS.
- 3. IT IS THE RESPONSIBILITY OF THE CONTRACTOR TO COORDINATE WITH THE AT&T MOBILITY REPRESENTATIVE AND LOCAL UTILITY COMPANY FOR THE INSTALLATION OF CONDUITS, CONDUCTORS, BREAKERS, DISCONNECTS, OR ANY OTHER EQUIPMENT REQUIRED FOR ELECTRICAL SERVICE. ALL ELECTRICAL WORK SHALL BE PERFORMED IN ACCORDANCE WITH LATEST EDITION OF THE STATE AND NATIONAL CODES, ORDINANCES AND REGULATIONS APPLICABLE TO THIS PROJECT.

LEGEND

GROUNDING TEST WELL AUTOMATIC TRANSFER SWITCH ATS **BOLLARD** CSC CELL SITE CABINET D DISCONNECT ELECTRICAL **FIBER** GEN GENERATOR GENERATOR RECEPTACAL HH, V HAND HOLE, VAULT ΙB ICE BRIDGE KENTROX BOX LC LIGHTING CONTROL M METER PB PULL BOX PΡ POWER POLE TELCO


TRANSFORMER

CHAINLINK FENCE

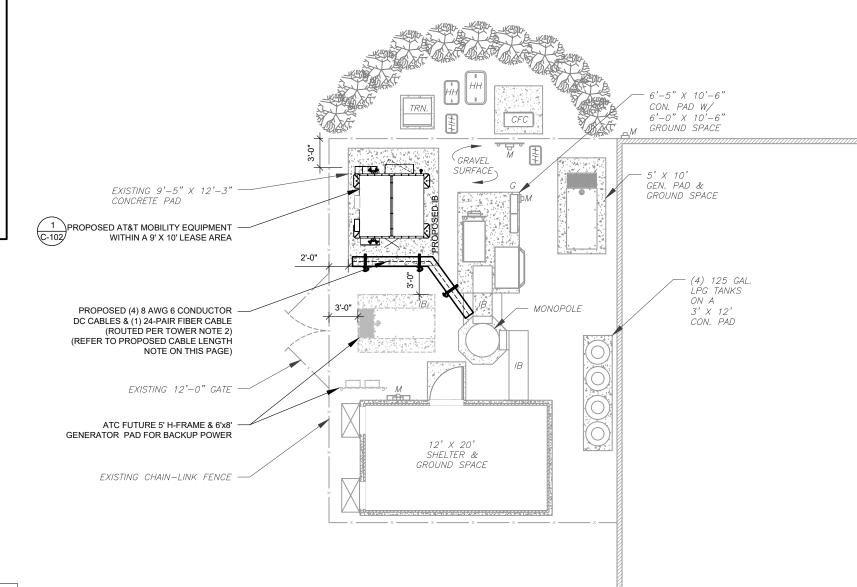

PROPOSED CABLE LENGTH:

- ESTIMATED LENGTH OF PROPOSED CABLE IS 155'.
 ESTIMATED LENGTH OF CABLE WAS PROVIDED BY
 CUSTOMER OR CALCULATED BY ADDING THE RAD
 CENTER AND THE DISTANCE FROM THE SHELTER
 ENTRY PLATE TO THE TOWER (ALONG THE ICE
 BRIDGE) AND A SAFETY FACTOR MEASUREMENT OF
 15% (OF THE TWO PREVIOUS VALUES), CDS DEFER
 TO GREATEST CABLE LENGTH.
- 2. ROUTE PROPOSED CABLES ALONG SAME PATH AS EXISTING CABLES AND IN ACCORDANCE WITH STRUCTURAL ANALYSIS. IF ADEQUATE SPACE EXISTS, ROUTE CABLES THROUGH ENTRY PORT HOLE, UP INSIDE OF MONOPOLE, AND THROUGH EXIT PORT HOLE. IF ROUTING OUTSIDE THE MONOPOLE, ATTACH CABLES USING STAND-OFF ADAPTERS MOUNTED TO TOWER USING STAINLESS STEEL BANDING. ADEQUATELY SECURE CABLES USING EITHER APPROPRIATELY SIZED STAINLESS STEEL SNAP-INS OR MOUNTING HARDWARE AND BRACKETS AS SPECIFIED BY CABLE MANUFACTURER.

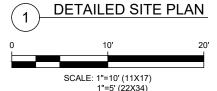





INFINIGY & ENGINEERING, PLLC

1033 WATERVLIET SHAKER RD ALBANY, NY 12205

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| LIM DB | 12/30/20 |
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| LIM RCD | 08/16/22 |
| LIM DGD | 09/14/22 |
| TRUCTION DGD | 09/16/22 |
| | LIM DB LIM SP LIM RCD LIM DGD |

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91567

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BELLINGHAM MAPLE STREET

SITE ADDRESS: 236 MAPLE STREET BELLINGHAM. MA 02019-3019

SEAL






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| П | ATC JOB NO: | 13330269_G2 |
| П | CUSTOMER ID: | MA1833 |
| П | CUSTOMER #: | 15336751 |
| | | |

DETAILED SITE PLAN

SHEET NUMBER:

C-101

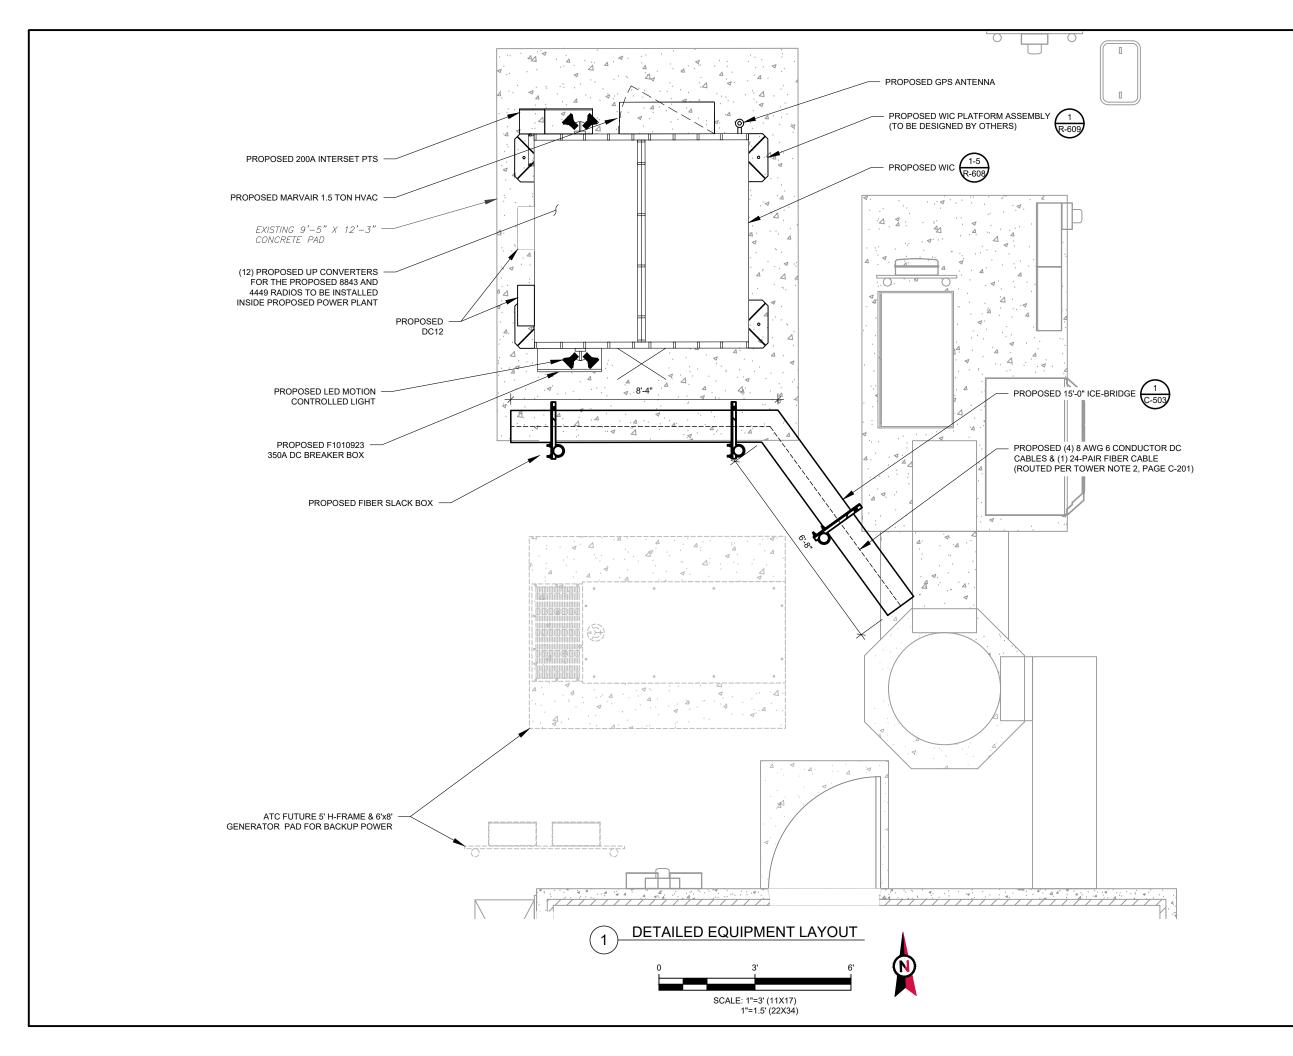



1033 WATERVLIET SHAKER RD ALBANY, NY 12205

| l | REV. | DESCRIPTION | BY | DATE |
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| l | <u> </u> | PRELIM | DB_ | 12/30/20 |
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SEAL





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| П | ATC JOB NO: | 13330269_G2 |
| П | CUSTOMER ID: | MA1833 |
| П | CUSTOMER #: | 15336751 |

DETAILED EQUIPMENT LAYOUT

SHEET NUMBER:

IMBER: REVISION:

C-102

EXISTING CONFIGURATION IS BASED ON RFDS. CONTRACTOR TO VERIFY EXISTING CONDITIONS

> PROPOSED AT&T MOBILITY ANTENNAS TOP OF PROPOSED EXTENSION (SEE TOWER NOTE 2) ELEV. 142.5' PROPOSED AT&T MOBILITY PROPOSED ELEV. (3) CCI TPA65R-BU8DA-K ANTENNAS (3) CCI DMP65R-BU8DA-K ANTENNAS PROPOSED 20' TOWER EXTENSION (3) ERICSSON AIR 6449 B77D ANTENNAS (3) ERICSSON 4449 B5/B12 RRHS (DESIGN BY OTHERS) (3) ERICSSON 8843 B2/B66A RRHS (3) ERICSSON 4478 B14 RRHS PROPOSED TOP OF EXISTING TOWER ANTENNA (1) RAYCAP DC9-48-60-24-8C-EV SQUID ELEV. 122.5 MOUNT (1) RAYCAP DC6-4860-0-8F SQUID (1) 24-PAIR FIBER CABLE (4) 8 AWG 6 CONDUCTOR DC CABLES XISTING T-MORILE ANTENNAS ELEV. 120.0 (3) SITE PRO 1 VFA12-M3-WLL SECTOR FRAMES EXISTING CARRIER ANTENNAS ELEV. 106.0°

> > - EXISTING TOWER

OF BASE PLATE

EXISTING CARRIER ANTENNAS

ELEV. 95.0

PER MOUNT ANALYSIS COMPLETED BY ATC, DATED 03/25/2021, THE EXISTING MOUNT CAN

PER STRUCTURAL ANALYSIS COMPLETED BY ATC, DATED 12/04/20, THE EXISTING TOWER CAN NOT ADEQUATELY SUPPORT THE PROPOSED LOADING. A TOWER MODIFICATION DESIGN SHALL BE COMPLETED AND MODIFICATION MUST BE INSTALLED PRIOR TO THE INSTALLATION OF THE PROPOSED ANTENNAS AND OTHER EQUIPMENT

ADEQUATELY SUPPORT THE PROPOSED LOADING

INFINIGY 8 **ENGINEERING, PLLC** 1033 WATERVLIET SHAKER RD ALBANY, NY 12205

AMERICAN TOWER®

ATC TOWER SERVICES, LLC

| REV. | DESCRIPTION | BY | DATE |
|----------------|------------------|--------------|----------|
| <u> </u> | PRELIM | DB_ | 12/30/20 |
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| | CUSTOMER #: | 15336751 |

TOWER ELEVATION

SHEET NUMBER:

REVISION

C-201

INFINIGY ENGINEERING HAS NOT EVALUATED THE TOWER OR MOUNTS FOR THIS PROJECT AND ASSUMES NO LIABILITY FOR ITS STRUCTURAL INTEGRITY. REFER TO STRUCTURAL ANALYSIS REPORT PRIOR TO CONSTRUCTION.


TOWER NOTE:

1. IT IS THE CONTRACTOR'S RESPONSIBILITY TO CONFIRM WITH THE AMERICAN TOWER CONSTRUCTION MANAGER THAT THEY HAVE THE MOST RECENT VERSION OF THE STRUCTURAL ANALYSIS BEFORE COMMENCING WORK. EXISTING AND PROPOSED TOWER APPURTENANCES, MOUNTS, AND ANTENNAS ARE SHOWN BASED ON THE STRUCTURAL ANALYSIS.

2. ROUTE PROPOSED CABLES ALONG SAME PATH AS EXISTING CABLES AND IN ACCORDANCE WITH STRUCTURAL ANALYSIS. IF ADEQUATE SPACE EXISTS, ROUTE CABLES THROUGH ENTRY PORT HOLE, UP INSIDE OF MONOPOLE, AND THROUGH EXIT PORT HOLE. IF ROUTING OUTSIDE THE MONOPOLE, ATTACH CABLES USING STAND-OFF ADAPTERS MOUNTED TO TOWER USING STAINLESS STEEL BANDING, ADEQUATELY SECURE CABLES USING FITHER APPROPRIATELY SIZED STAINLESS STEEL SNAP-INS OR MOUNTING HARDWARE AND BRACKETS AS SPECIFIED BY CABLE MANUFACTURER.

TOWER ELEVATIONS ARE MEASURED FROM TOP OF BASE PLATE TO MATCH STRUCTURAL ANALYSIS. ELEVATIONS DO NOT REFLECT TRUE ABOVE GROUND LEVEL (A.G.L.)

TOWER ELEVATION SCALE: N.T.S.

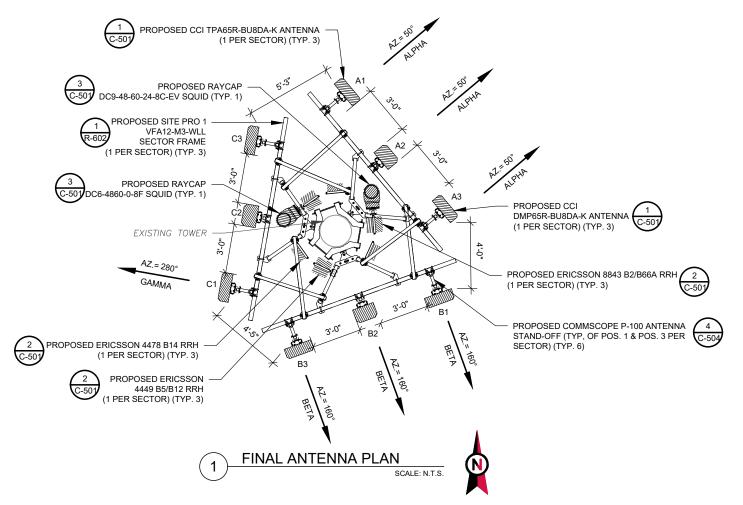

| | | | | FINAL ANTENNA SCH | EDULE | | | | | |
|------------|------|-------|-----------------------------|-----------------------------|-----------------------------|----------------|--------|------------------------------------|-----------------------------|-----|
| LOCATION | | | AN | ITENNA SUMMARY | | | | NON ANTENNA SUMMARY | | |
| SECTOR RAD | AZ | POS | ANTENNA | BAND | MECH D-TILT | ELEC D-TILT | STATUS | ADDITIONAL TOWER MOUNTED EQUIPMENT | STATUS | |
| | | A1 | CCI ANTENNAS TPA65R-BU8DA-K | LTE 700, LTE AWS | 0 | - | ADD | 4478 B14 | ADD | |
| ALPHA 135' | 50° | A2 | ERICSSON AIR 6449 B77D | LTE 3.5 GHZ | 0 | - | ADD | - | - | |
| | | А3 | CCI ANTENNAS DMP65R-BU8DA-K | LTE 700, 5G 850 LTE 1900 | 0 | - | ADD | 4449 B5/B12 8843 B2/B66A | ADD | |
| | | B1 | CCI ANTENNAS TPA65R-BU8DA-K | LTE 700, LTE AWS | 0 | - | ADD | 4478 B14 | ADD | |
| BETA 135' | 160° | B2 | ERICSSON AIR 6449 B77D | LTE 3.5 GHZ | 0 | - | ADD | - | - | |
| | | В3 | CCI ANTENNAS DMP65R-BU8DA-K | LTE 700, 5G 850 LTE 1900 | 0 | - | ADD | 4449 B5/B12 8843 B2/B66A | ADD | |
| | | C1 | CCI ANTENNAS TPA65R-BU8DA-K | LTE 700, LTE AWS | 0 | - | ADD | 4478 B14 | ADD | |
| GAMMA 135' | 280° | C2 | ERICSSON AIR 6449 B77D | LTE 3.5 GHZ | 0 | - | ADD | - | - | |
| | 200 | , 200 | СЗ | CCI ANTENNAS DMP65R-BU8DA-K | LTE 700, 5G 850 LTE 1900 | 0 | - | ADD | 4449 B5/B12 8843 B2/B66A | ADD |

2. CONFIRM SPACING OF PROPOSED EQUIP DOES NOT CAUSE TOWER CONFLICTS NOR IMPEDE TOWER CLIMBING PEGS.

2 ANTENNA SCHEDULE

CABLE LENGTHS FOR JUMPERS
FIBER DISTRIBUTION/OVP TO RRU: 15'
RRU TO COMBINER: 10'
COMBINER TO ANTENNA: 10'

| PROPOSED FIBER DISTRIBUTION | PROPOSED CABLING SUMMARY | | | | |
|-----------------------------|--------------------------|------|----------------------------|-------------|--------|
| MODEL NUMBER | STATUS | COAX | DC | FIBER | STATUS |
| (1) DC9-48-60-24-8C-EV | ADD | - | (2) #8 AWG, 6 CONDUCTOR | (1) 24-PAIR | ADD |
| (1) DC6-4860-0-8F | ADD | - | (2) #8 AWG, 6 CONDUCTOR | - | ADD |



INFINIGY & ENGINEERING, PLLC

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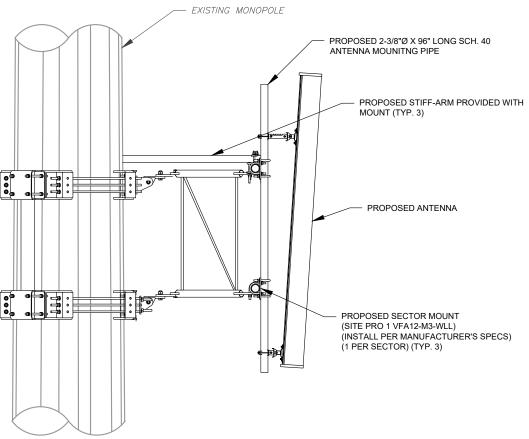


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| | П | CUSTOMER ID: | MA1833 |
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| | | | |

ANTENNA INFORMATION & SCHEDULE


SHEET NUMBER:

C-401




PROPOSED ANTENNA MOUNTING DETAIL (ELEVATION)

PROPOSED RRU MOUNTED TO SWIVEL MOUNT PROPOSED MAST PIPES ON THE V-SECTION OF THE MOUNT

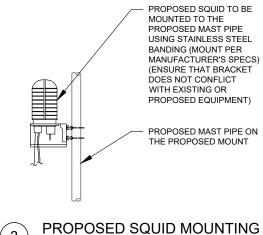

RF REQUIREMENTS FOR 700 B14 FIRSTNET, 700 B12, 700D B29 ANTENNA SEPARATION

- ☐ Horizontal separation (side to side of antenna): >= 3'
- $lue{}$ Vertical separation (between the tips of the antennas): > 3'
- ☐ Inter-sector separation: > 3' between the center of the antenna backplanes.

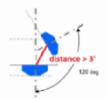

- ☐ Please note additional horizontal separation may be required if B14 antennas azimuth are different from others or antennas are severely angled with respect to the mount.
- ☐ Typical 3' horizontal separation can tolerate skew angle up to 6°.





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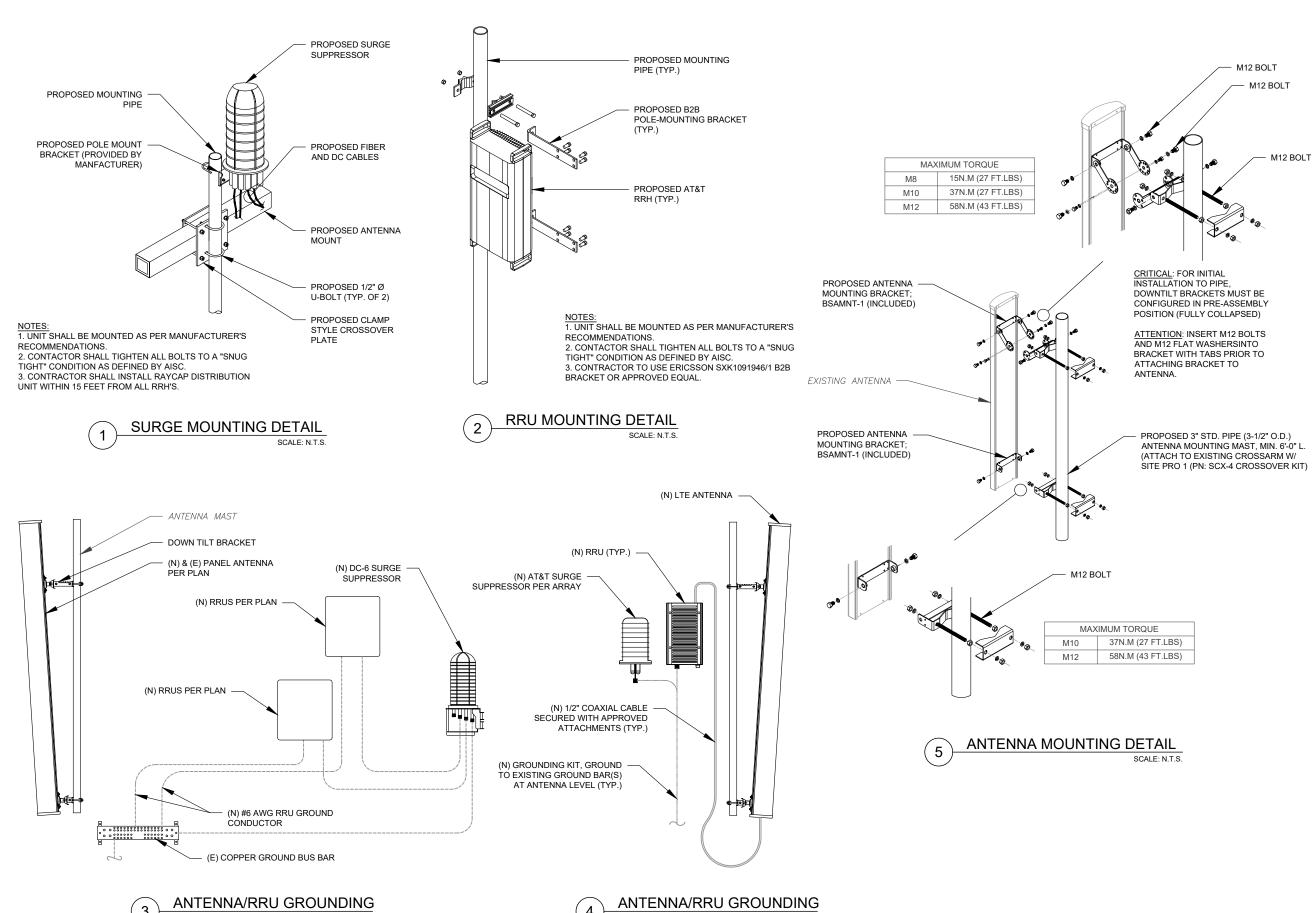


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CONSTRUCTION DETAILS

SHEET NUMBER

C-501





1033 WATERVLIET SHAKER RD ALBANY, NY 12205

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| l | /c\ | PRELIM | RCD | 08/16/22 |
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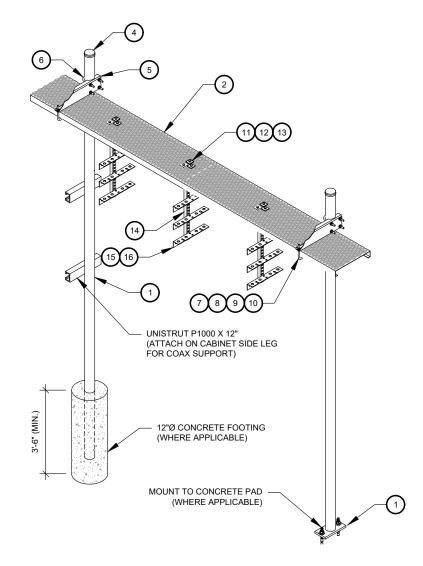
CONSTRUCTION DETAILS

SHEET NUMBER:

C-502

CONSTRUCTION NOTE:


1. INSTALL ICE BRIDGE TO ALLOW 7 FEET CLEARANCE ABOVE GRADE TO LOWEST APPURTENANCE.




| WB- | WB-K210-B WAVEGUIDE BRIDGE KIT - BILL OF MATERIALS (INCLUDED WITH KIT UNLESS NOTED OTHERWISE) | | | | | |
|-------|---|--|------|----------------|---|--|
| ITEM | PART NUMBER | DESCRIPTION | ITEM | PART NUMBER | DESCRIPTION | |
| 1 | MF126.01 MF-130 | 10'-4" COLUMN & BASE SHOE* 13'-4" PIPE COLUMN | 9 | GWL-04 | 1/2" GALV LOCK WASHER | |
| 2 | WB-CY210 | SAFETY GRATING 24" X 10' | 10 | GN-04 | 1/2" GALV HEX NUT | |
| 3 | WBK110BHK | HARDWARE KIT (ITEMS 4-16) | 11 | GB-03205 | 3/8" X 2" GALV BOLT KIT | |
| 4 | PC-034 | PIPE CAP 3-1/2" | 12 | MT-387 | SQUARE WASHER, 1-1/2" X 1-1/2" W/ 7/16" HOLE | |
| 5 | WBLB243.08 | 24" WAVEGUIDE BRIDGE SUPPORT BRACKET | 13 | GWF-03 | 3/8" GALV FLAT WASHER | |
| 6 | GUB-4356 | 1/2" X 3-5/8" X 6" GALV U-BOLT | 14 | WBT243.01 | VERTICAL TRAPEZE SECTION | |
| 7 | WB-JB-6 | 1/2" J-BOLT | 15 | GB-03105 | 3/8" X 1" GALV BOLT KIT | |
| 8 | GWF-04 | 1/2" GALV FLAT WASHER | 16 | WBT243.02 | HORIZONTAL TRAPEZE SECTION | |
| CONTR | CONTRACTOR SHALL USE PARTS MANUFACTURED BY COMMSCOPE OR APPROVED EQUIVALENT. | | | | | |

#2 AWG BTCW, TYP @ 3 PLACES CABLE TO PIPE CONNECTOR BURNDY TYPE GAR NOTE: INFINIGY HAS NOT VERIFIED THIS DESIGN FOR THE 1-1/4"ø PIPE PROJECT AND ASSUMES NO RESPONSIBILITY FOR THE STRUCTURAL STABILITY. CONTINUOUS BEAD OF SILICONE SEALANT @ TOP OF UNISTRUT - CONDUIT CLAMP NEOPRENE WASHER @ THREADED ROD (TYP.) ANCHORAGE: AT CONCRETE USE — 3/8" THREADED ROD W/ HILTI HY-150 @ MIN. 1-3/4" EMBED. - 12" MIN. LENGTH UNISTRUT (ICBO 5193); AT WOOD USE P1000 (TYP.) 3/8"X3" LAG BOLTS; AT METAL STUDS USE #12X3" SHEET METAL SCREWS (2 TOTAL PER UNISTRUT). #6 AWG GROUNDING KIT PROPOSED WIC--1/2"ø COAXIAL CABLE - COPPER ISOLATED GROUND BUS

GPS ANTENNA ATTACHMENT DETAIL

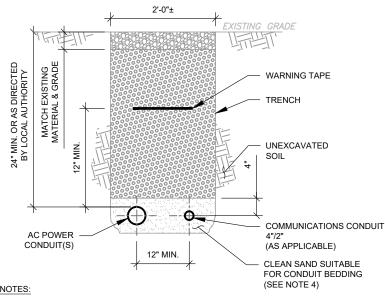

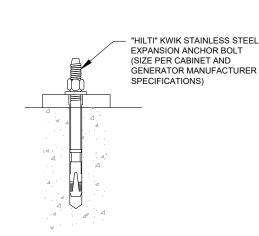

- IF FREE OF ORGANIC OR OTHER DELETERIOUS MATERIAL, EXCAVATED MATERIAL MAY BE USED FOR BACKFILL. IF NOT, PROVIDE CLEAN, COMPACTIBLE MATERIAL.

 COMPACT IN 8" LIFTS. REMOVE ANY LARGE ROCKS PRIOR TO BACKFILLING. CONTRACTOR
- TO VERIFY LOCATION OF EXISTING U/G UTILITIES PRIOR TO DIGGING.
- IF CURRENT AS-BUILT DRAWINGS ARE NOT AVAILABLE CONTRACTOR SHALL HAND DIG
- USE COMMUNICATIONS ONLY TRENCH FOR COMMUNICATIONS CONDUIT UNLESS TRAVELING UNDER PATH OF VEHICLE TRAVEL, THEN CONDUIT MUST BE 24" MIN. BELOW GRADE
- CONFIRM SPACING AND DEPTH WITH NEC OR LOCAL CODE REQUIREMENTS

EXPANSION ANCHOR DETAIL

POWER/TELCO CONDUIT TRENCH DETAILS

SCALE: N.T.S.



INFINIGY 8 **ENGINEERING, PLLC**

1033 WATERVLIET SHAKER RD ALBANY, NY 12205

| REV. | DESCRIPTION | BY | DATE |
|----------|------------------|------------|----------|
| <u> </u> | PRELIM | DB_ | 12/30/20 |
| <u> </u> | PRELIM | SP | 08/15/22 |
| <u> </u> | PRELIM | RCD | 08/16/22 |
| ₾_ | PRELIM | DGD . | 09/14/22 |
| <u> </u> | FOR CONSTRUCTION | <u>DGD</u> | 09/16/22 |

ATC SITE NUMBER:

91567

ATC SITE NAME:

RJ COBB

AT&T MOBILITY SITE NAME:

BELLINGHAM MAPLE STREET

SITE ADDRESS: 236 MAPLE STREET BELLINGHAM, MA 02019-3019





| | DATE DRAWN: | 09/16/22 |
|--|--------------|-------------|
| | ATC JOB NO: | 13330269_G2 |
| | CUSTOMER ID: | MA1833 |
| | CUSTOMER #: | 15336751 |
| | | |

CONSTRUCTION **DETAILS**


SHEET NUMBER:

C-503

REVISION 0


WAVEGUIDE BRIDGE KIT SCALE: NOT TO SCALE


*BASE SHOE NOT INCLUDED IN WB-K210-B KIT, ORDER COLUMN SEPARATELY OR KIT WB-K210-S.

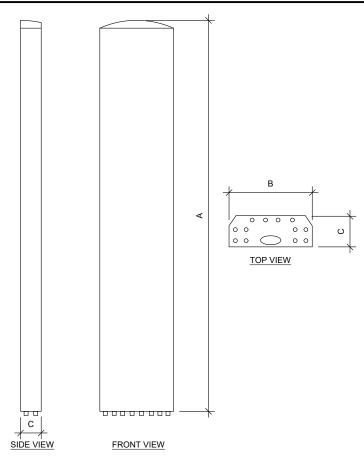


| ANTENNA SPECIFICATIONS | | | | | |
|------------------------|-----|-------|-------|-----------------|--|
| ANTENNA MODEL | А | В | С | WEIGHT (LBS) | |
| CCI TPA65R-BU8DA-K | 96" | 21" | 7.8" | 83 | |
| CCI DMP65R-BU8DA-K | 96" | 20.7" | 7.7" | 96 | |
| AIR6449 B77D | 31" | 16" | 10.6" | 81.6 | |

ANTENNA SPECIFICATIONS

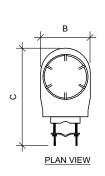

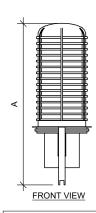

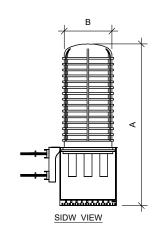


| RAYCAP SPECIFICATIONS | | | | | | | |
|-----------------------|-------|-------|-------|-----------------|--|--|--|
| RAYCAP MODEL | А | В | С | WEIGHT (LBS) | | | |
| DC9-48-60-24-8C-EV | 31.4" | 18.3" | 10.2" | 16 | | | |
| DC6-48-60-0-8F | 22.3" | 11" | 11" | 32.8 | | | |

RAYCAP SPECIFICATIONS




TOP VIEW

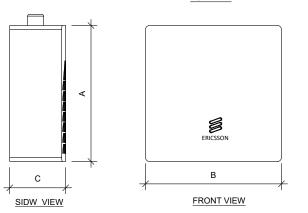

| RRU SPECIFICATIONS | | | | |
|--------------------|-------|-------|-------|-----------------|
| RRU MODEL | А | В | С | WEIGHT (LBS) |
| 4478 B14 | 16.5" | 13.4" | 5.9" | 59.9 |
| 4449 B5/B12 | 17.9" | 13.2" | 9.4" | 71 |
| 8843 B2/B66A | 14.9" | 13.2" | 10.9" | 72 |

RRU SPECIFICATIONS NOT TO SCALE

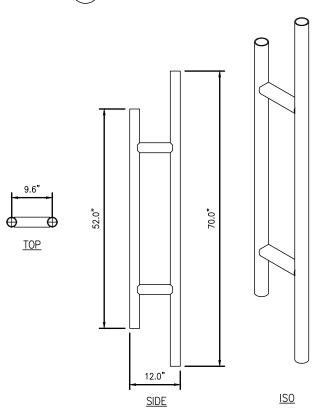

COMMSCOPE P-100 ANTENNA STAND-OFF MOUNT DETAIL SCALE: N.T.S.



INFINIGY8 ENGINEERING, PLLC 1033 WATERVLIET SHAKER RD ALBANY, NY 12205

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ATC SITE NUMBER:

91567

ATC SITE NAME:

RJ COBB

AT&T MOBILITY SITE NAME:

BELLINGHAM MAPLE STREET

SITE ADDRESS: 236 MAPLE STREET BELLINGHAM, MA 02019-3019






| ı | | |
|---|--------------|-------------|
| | DATE DRAWN: | 09/16/22 |
| ı | ATC JOB NO: | 13330269_G2 |
| ı | CUSTOMER ID: | MA1833 |
| | CUSTOMER #: | 15336751 |
| 1 | | |

EQUIPMENT SPECIFICATIONS

SHEET NUMBER:

C-504

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1033 WATERVLIET SHAKER RD ALBANY, NY 12205
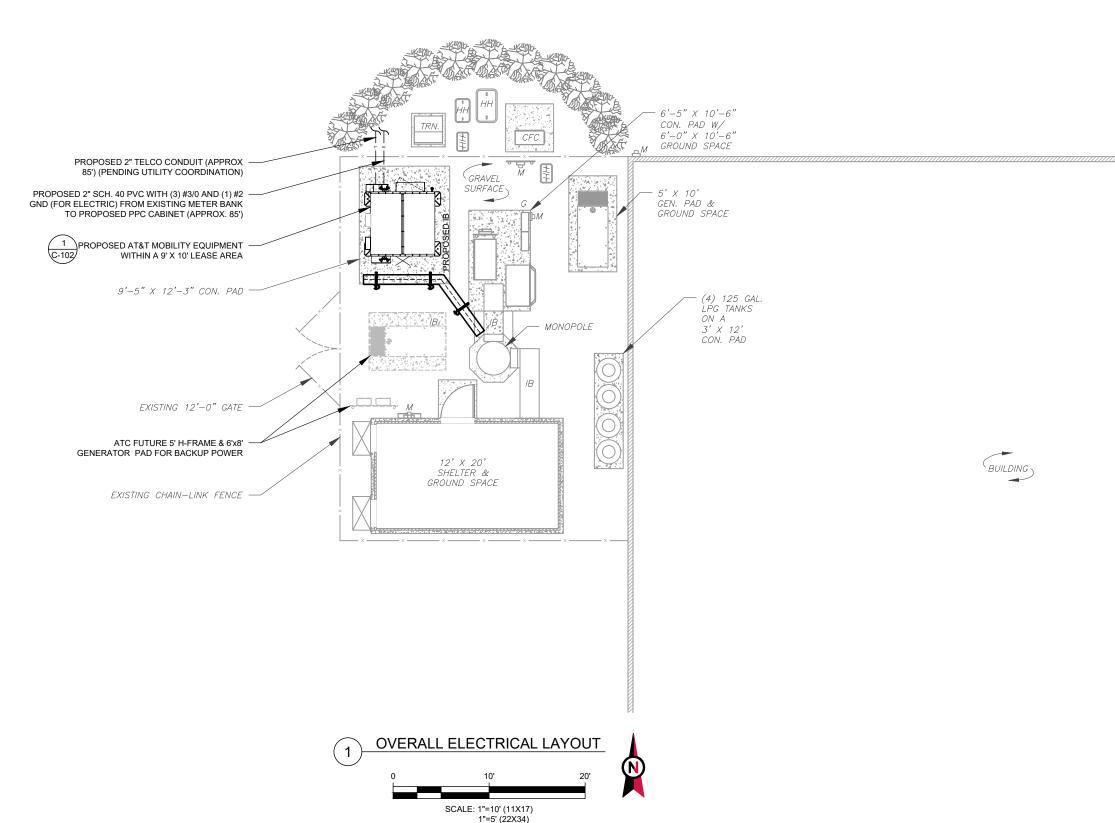
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| /c\ | PRELIM | RCD | 08/16/22 |
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AT&T MOBILITY SITE NAME:

BELLINGHAM MAPLE STREET

SITE ADDRESS: 236 MAPLE STREET BELLINGHAM, MA 02019-3019

SEAL:






| | DATE DRAWN: | 09/16/22 |
|---|--------------|-------------|
| П | ATC JOB NO: | 13330269_G2 |
| П | CUSTOMER ID: | MA1833 |
| П | CUSTOMER #: | 15336751 |
| | | |

OVERALL ELECTRICAL LAYOUT

SHEET NUMBER:

E-101

0

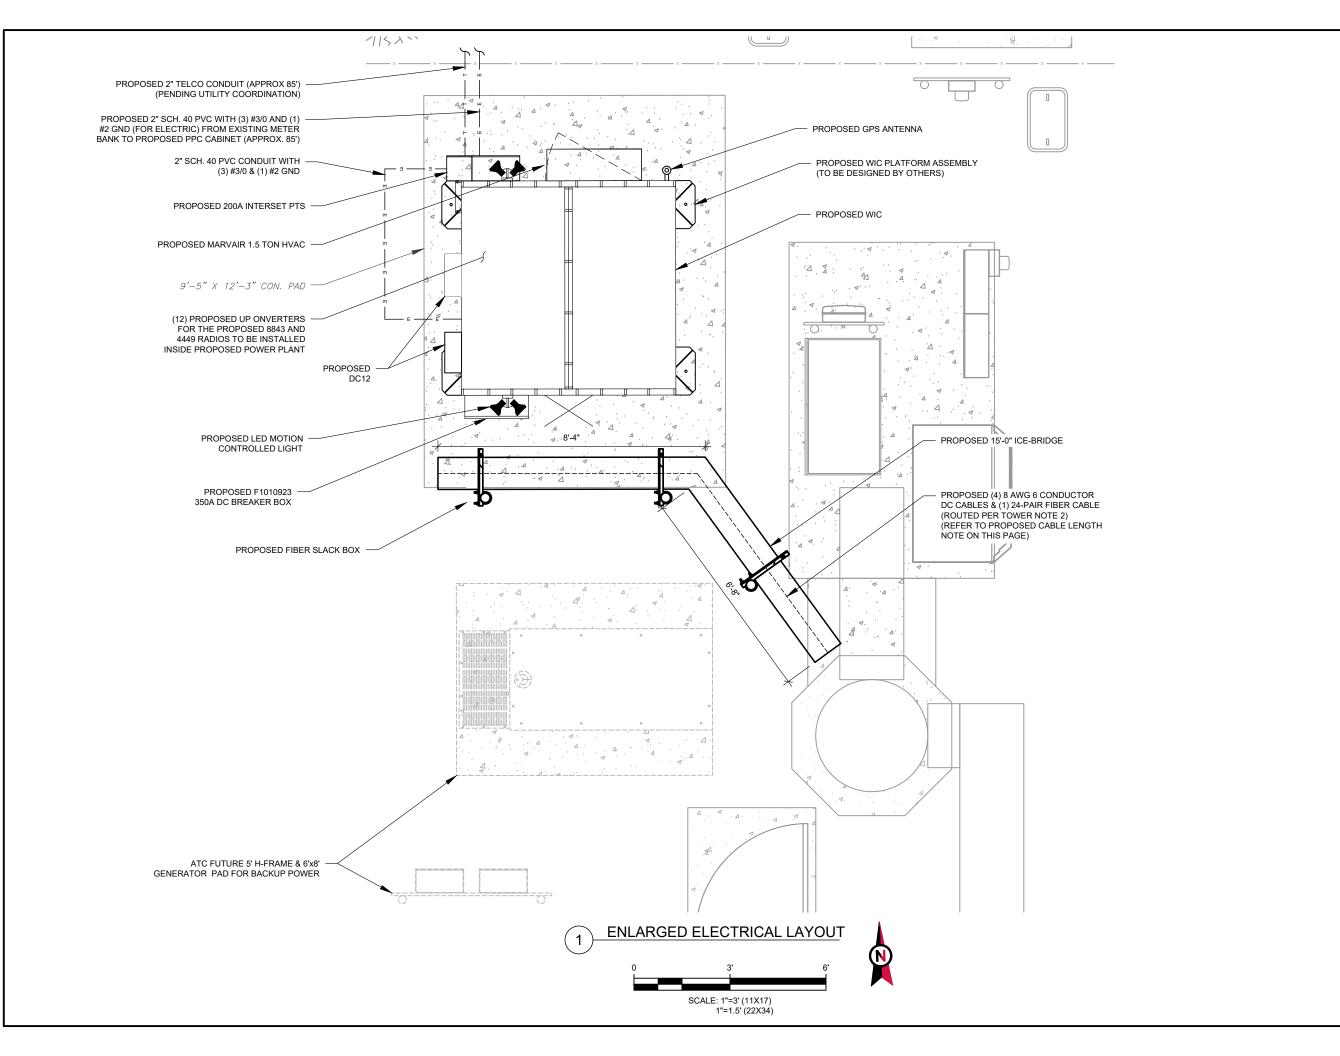



1033 WATERVLIET SHAKER RD ALBANY, NY 12205

| REV. | DESCRIPTION | BY | DATE |
|------------------|------------------|------------|----------|
| \mathbb{A}_{-} | PRELIM | DB | 12/30/20 |
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| <u>&</u> _ | PRELIM | _ RCD | 08/16/22 |
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SITE ADDRESS: 236 MAPLE STREET BELLINGHAM. MA 02019-3019

SEAL





| | DATE DRAWN: | 09/16/22 |
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| | ATC JOB NO: | 13330269_G2 |
| | CUSTOMER ID: | MA1833 |
| | CUSTOMER #: | 15336751 |

ENLARGED ELECTRICAL LAYOUT


SHEET NUMBER:

REVISION:

E-102

ELECTRICAL NOTES:

- POWER TRANSFER LOAD CENTER (PTLC) INCLUDES A CAM-LOC GENERATOR CONNECTION PANEL, AND ATS, A MECHANICALLY INTERLOCKED TRANSFER SWITCH, A 200A 42 CIRCUIT PANEL AND SURGE SUPPRESSION.
- CONTRACTOR SHALL FURNISH AND INSTALL POWER CONDUCTORS (3#3/0, #6 G IN 2"C) FROM METER CENTER TO SHELTER. METER WILL BE FURNISHED AND INSTALLED BY LOCAL UTILITY COMPANY.
- CONTRACTOR SHALL PROVIDE AND INSTALL CIRCUIT BREAKER IN METER CENTER TO FEED AT&T SHELTER. CIRCUIT BREAKER SHALL BE 200A, 240V, 1PH, 3W TYP AND AIC RATING SHALL MATCH EXISTING.
- CONTRACTOR SHALL PROVIDE AND INSTALL NAMEPLATE ON METER TO INDICATE "AT&T". NAMEPLATES SHALL BE PHENOLIC, WHITE LETTERS ON BLACK BACKGROUND.
- SHELTER DISCONNECT IS FURNISHED WITH SHELTER. ON SITES WHERE SERVICE IS OBTAINED FROM AN EXISTING SOURCE (METER CENTER), OR SERVICE DISCONNECT IS LOCATED ON EQUIPMENT RACK, SHELTER DISCONNECT MAY BE OMITTED.
- BELOW GRADE PVC CONDUIT SHALL TRANSITION TO RMC PRIOR TO RISING ABOVE GRADE, ALL BENDS SHALL HAVE A MINIMUM 24" RADIUS. ALL FITTINGS SHALL BE SUITABLE FOR USE WITH THREADED RIGID CONDUIT. VERIFY CONDUIT TYPE WITH LOCAL CONSTRUCTION MANAGER AND ADJUST IF NECESSARY. ALL CONDUIT SHALL MEET NEC, STATE, AND LOCAL CODE REQUIREMENTS AS REQUIRED.
- ALL EQUIPMENT SHALL BE GROUNDED PER NEC (MIN #2 SBTC) AND AT&T STANDARDS.
- CONDUCTOR SIZES AND DISTANCES HAVE BEEN SIZED FOR 3% MAX VOLTAGE DROP. (TOTAL SYSTEM VOLTAGE DROP ON BOTH FEEDERS AND BRANCH CIRCUITS TO THE FARTHEST DEMAND SHALL NOT EXCEED 5%)

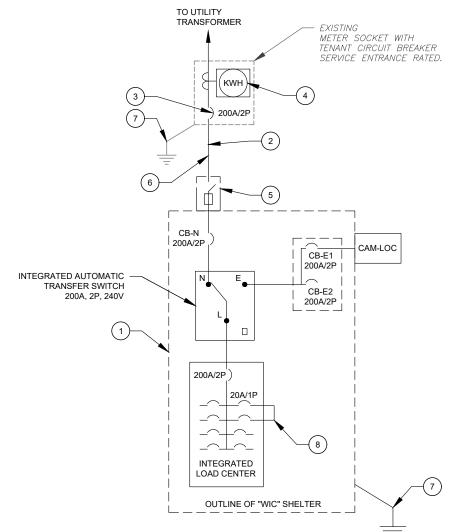

| ANEL | ATION: | AT&T | TYPE: MOUNTING: | LIGH | TING & APPL SURFACE | IANCE | - | SYSTEM MAIN BI | |) (MR) | 120/240V, 3W, 42 CKT B): 200A | | CKT LOCATION: | | SE AREA | | |
|-------------------|--------|-------------------|--------------------|---------------|------------------------|---------|-------|-------------------|-----------|--------|----------------------------------|-------------|----------------|--------------------------------------|----------|------------|--|
| LOIGIN | | AIGI | ENCLOSURE | | 30KFACE | | - | MAIN B | | . , | 200A | | PANEL NOTES: | WIC INTEGRATED PANEL | | | |
| | | | LINCLOSUKE | | | | | MIN. A.I | | | 65K | | FANLE NOTES. — | VVIC INTEGRA | TILDFAIL | | |
| | | | | | | | • | IVIIIN. A.I | I.C. KATI | NG. | | | _ | | | | |
| CONNE | CTED | | | FEED | ER OR BRAN | CH CIRC | UIT | | | FEED | ER OR BRANCH | CIRCUIT | | | CONN | IECTED | |
| LOAD | (kVA) | BRIEF DESCRIPTION | | BR | EAKER | POLE | CIRC. | 1 | CIRC. | POLE | BRE | AKER | BRIEF C | DESCRIPTION | LOAD | LOAD (kVA) | |
| Α | В | | АМ | PS | POLES | NO. | NOTES | | NOTES | NO. | POLES | AMPS | | | Α | В | |
| 2.00 | | RECTIFIER #1 | 30 | $\overline{}$ | 2 | 1 | | | | 2 | 1 | 20 | EXT. GF | CIOUTLETS | 0.18 | | |
| | 2.00 | RECTIFIER #1 | 3 | ١ ١ | 2 | 3 | | | | 4 | 2 | 30 | DEC | TIFIER #2 | | 2.00 | |
| 2.00 | | RECTIFIER #3 | 30 | <u> </u> | 2 | 5 | | | | 6 | | 30 | KLO | TII ILIX #2 | 2.00 | | |
| | 2.00 | KEGTII IEK #3 | 3. | | | 7 | | | | 8 | 2 | 30 | REC | TIFIER #4 | | 2.00 | |
| 2.00 | | RECTIFIER #5 | 30 | o | 2 | 9 | | | | 10 | | | I I I | | 2.00 | | |
| | 2.00 | | , i | | | 11 | | | | 12 | 2 | 30 | RECTIFIER #6 | | | 2.00 | |
| 0.00 | | SPACE | | | | 13 | | | | 14 | | | | | 2.00 | L | |
| | 0.00 | SPACE | | | | 15 | | | | 16 | | | | PACE | | 0.00 | |
| 0.68 | | SPACE | | | | 17 | | | | 18 | | | | PACE | 0.00 | <u> </u> | |
| | 0.00 | SPACE | | | | 19 | | | | 20 | | | | PACE | | 0.00 | |
| 0.00 | | SPACE | | | | 21 | | | | 22 | | | | PACE | 0.00 | L | |
| | 0.00 | SPACE | | | | 23 | | | | 24 | | | | PACE | | 0.00 | |
| 3.50 | | 1.5 TON AC UNIT | 20 | o | 2 | 25 | | | | 26 | | | | SPACE | 0.00 | | |
| | 3.50 | | | | | 27 | | | | 28 | | | | PACE | | 0.00 | |
| 0.48 | | FIBER BOX OUTLET | 20 |) | 1 | 29 | | | | 30 | | | | PACE | 0.00 | | |
| | 0.00 | SPACE | | | | 31 | | | | 32 | | | | PACE | | 0.00 | |
| 0.00 | | SPACE | | | | 33 | | | | 34 | | | | PACE | 0.00 | | |
| | 0.00 | SPACE | | | | 35 | | | | 36 | | | | PACE | | 0.00 | |
| 0.00 | 0.00 | SPACE | | \rightarrow | | 39 | | | | 40 | | | | PACE | 0.00 | 1000 | |
| \longrightarrow | 0.00 | SPACE | | | | 41 | | | | 42 | - | | l s | PACE | _ | 0.00 | |
| 10.7 | 9.5 | | | | | | Α | В | TO | |] | | | | 8.1 | 8.6 | |
| | | | | | | | 18.8 | 18.1 | 36 | | CONNECTED LO | | | | | | |
| | | | | | | | 18.8 | 18.1 |] 36 | 6.9 | DEMAND LOAD | (kVA) | | RATING FACTOR (8) DEMANDLOAD SIZI | | AMPS | |

1. ALL CONDUCTORS ARE TYPE THWN (75°C) COPPER.

2. MAXIMUM LENGTH OF RUN FOR RECTIFIER CIRCUITS IS 50 FT.



ELECTRICAL ONE-LINE DIAGRAM

SCALE: NOT TO SCALE

- ALL EQUIPMENTS' SHORT-CIRCUIT CURRENT RATING SHALL EXCEED AVAILABLE FAULT CURRENT PER UTILITY
- 2. CONTRACTOR TO INSTALL HANDHOLES AT EVERY 3RD 90° TURN



INFINIGY8

1033 WATERVLIET SHAKER RD ALBANY, NY 12205

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ATC SITE NUMBER:

91567

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RJ COBB

AT&T MOBILITY SITE NAME:

BELLINGHAM MAPLE STREET

SITE ADDRESS: 236 MAPLE STREET BELLINGHAM, MA 02019-3019






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|---|--------------|-------------|
| I | DATE DRAWN: | 09/16/22 |
| I | ATC JOB NO: | 13330269_G2 |
| I | CUSTOMER ID: | MA1833 |
| I | CUSTOMER #: | 15336751 |
| | | |

ELECTRICAL ONE-LINE & PANEL SCHEDULE

SHEET NUMBER:

E-103

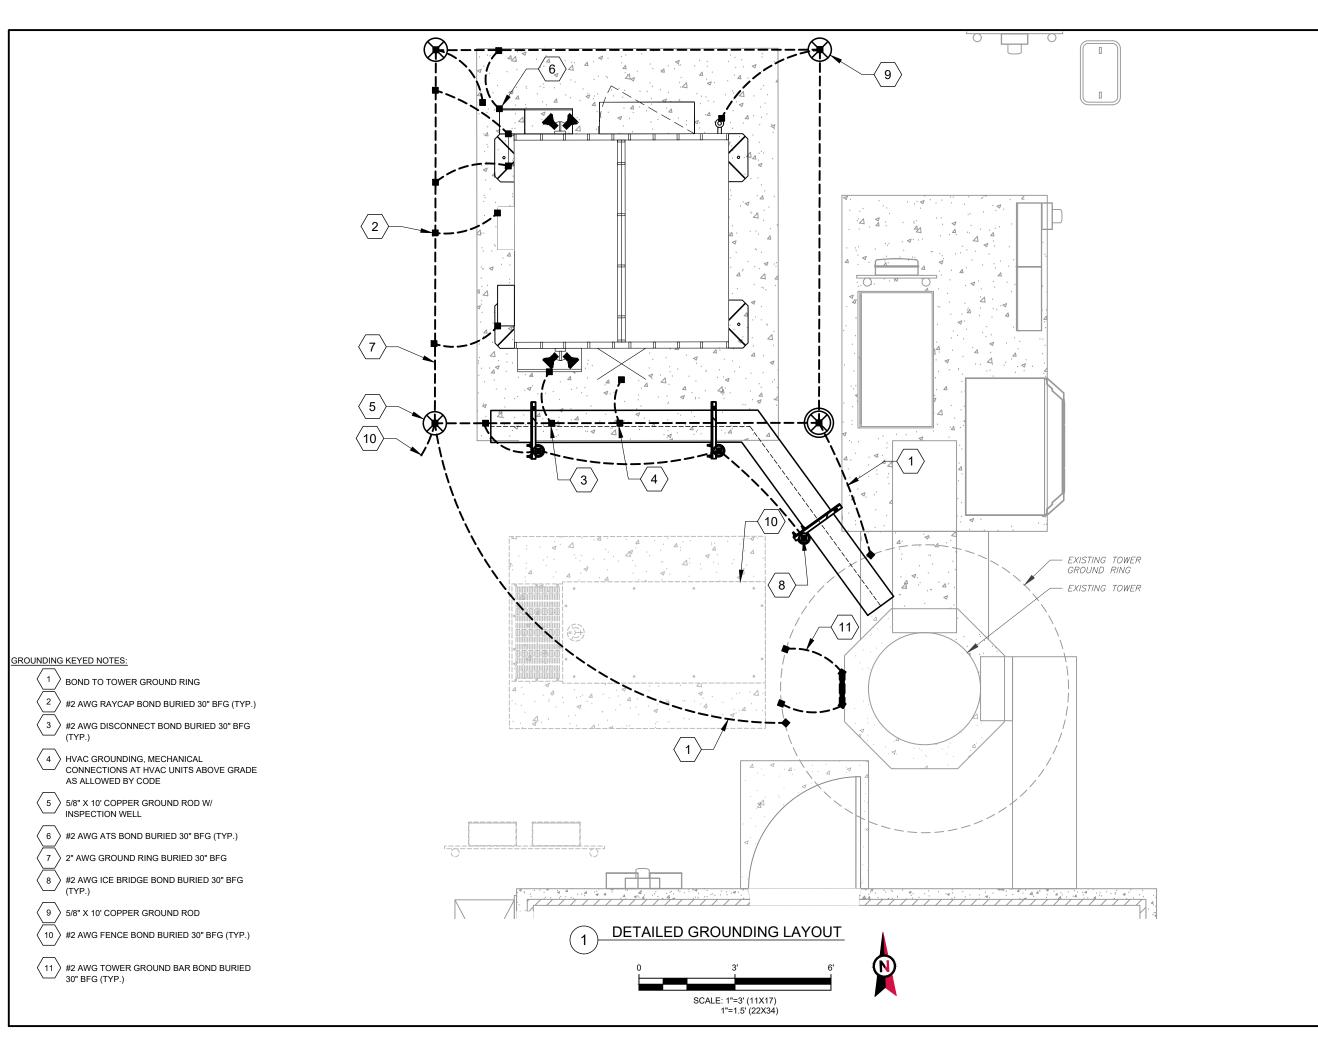



INFINIGY8 ENGINEERING, PLLC 1033 WATERVLIET SHAKER RD

ALBANY, NY 12205

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| <u> </u> | PRELIM | <u></u> | 12/30/20 |
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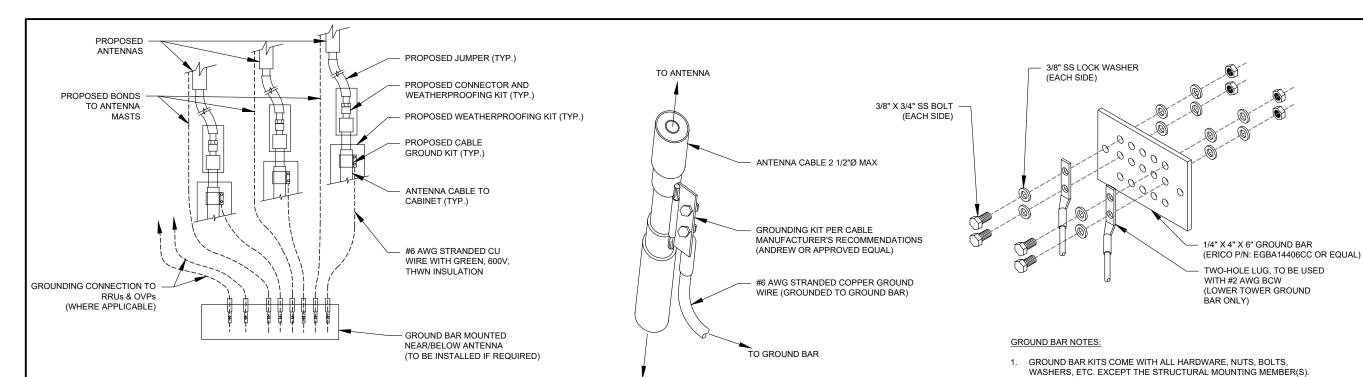
| DATE DRAWN: | 09/16/22 |
|--------------|-------------|
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| CUSTOMER #: | 15336751 |
| | |

DETAILED GROUNDING LAYOUT

SHEET NUMBER:


REVISION:

E-104



- 1. THIS DETAIL IS INTENDED TO SHOW THE GENERAL GROUNDING REQUIREMENTS. SLIGHT ADJUSTMENTS MAY BE REQUIRED BASED ON EXISTING SITE CONDITIONS. THE CONTRACTOR SHALL MAKE FIELD ADJUSTMENTS AS NEEDED AND INFORM THE CONSTRUCTION MANAGER OF ANY CONFLICTS.
- SITE GROUNDING SHALL COMPLY WITH AT&T GROUNDING STANDARDS, LATEST EDITION, AND COMPLY WITH AT&T GROUNDING CHECKLIST, LATEST VERSION. WHEN NATIONAL AND LOCAL GROUNDING CODES ARE MORE STRINGENT THEY SHALL GOVERN.

TYPICAL ANTENNA GROUNDING DIAGRAM

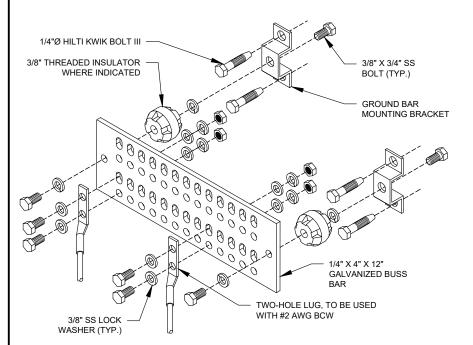

GROUND BAR NOTES

- GROUND KITS COME WITH ALL HARDWARE, NUTS, BOLTS, WASHERS, ETC. EXCEPT THE STRUCTURAL MOUNTING MEMBER(S).
- 2. GROUND BAR SHALL BE BOLTED TO STRUCTURAL MEMBER OR ANCHORED TO CONCRETE SLAB W/ HILTI KWIK BOLT III.

TO EQUIPMENT

- GROUND KIT NOTES:


 1. DO NOT INSTALL CABLE GROUND KIT AT A BEND AND ALWAYS DIRECT GROUND WIRE DOWN TO GROUND BAR.
- 2. CONTRACTOR SHALL PROVIDE WEATHERPROOFING KIT (ANDREW PART NUMBER 221213) AND INSTALL/TAPE PER MANUFACTURER'S SPECIFICATIONS


CABLE GROUND KIT CONNECTION DETAIL

TOWER GROUND BAR DETAIL

2. GROUND BAR TO BE BONDED DIRECTLY TO TOWER.

- SEPARATION DIMENSION TO BE VERIFIED WITH LOCAL UTILITY COMPANY
- 2. COORDINATE UTILITY, LOCATE BEFORE DIGGING.
- CONDUIT TRENCHING DEPTHS AT 36" OR 6" BELOW FROST LINE, WHICHEVER IS GREATER.
- ALL RING AND RADIAL DEPTHS AT 30" OR 6" BELOW FROST LINE, WHICHEVER IS GREATER.

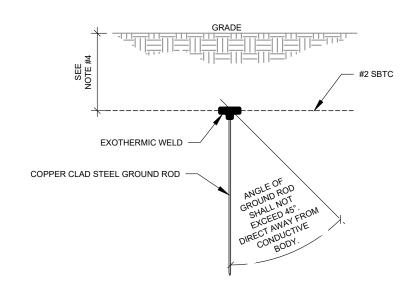

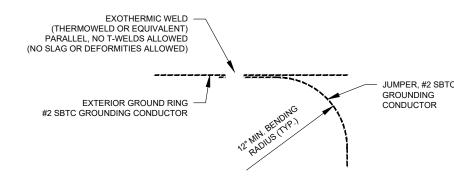

GROUND ROD DETAIL

TIE CONNECTION DETAIL



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1033 WATERVLIET SHAKER RD ALBANY, NY 12205

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GROUNDING DETAILS

SHEET NUMBER:


E-501


REVISION



MAIN GROUND BAR DETAIL

SCALE: NOT TO SCALE

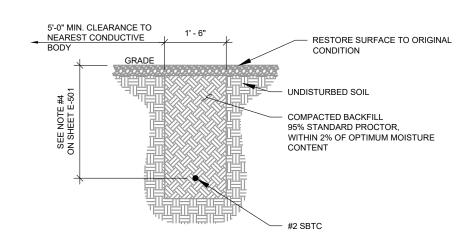

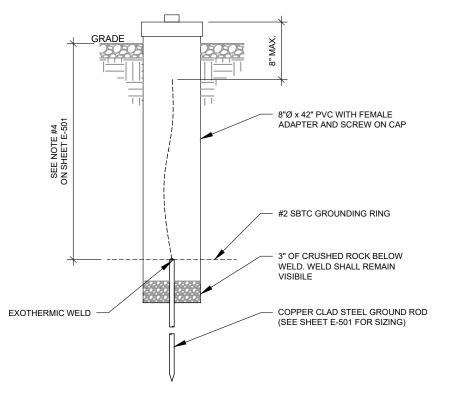

1 GROUND CONNECTION TRENCH DETAIL (STD.)

2 TEST WELL DETAIL
SCALE: NOT TO SCALE



INFINIGY ENGINEERING, PLLC

1033 WATERVLIET SHAKER RD ALBANY, NY 12205

| PTION BY | DATE |
|--------------|---|
| LIM DB | 12/30/20 |
| LIM SP | 08/15/22 |
| LIM RCD | 08/16/22 |
| LIM DGD | 09/14/22 |
| TRUCTION DGD | 09/16/22 |
| | LIM DB LIM SP LIM RCD LIM DGD |

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SEAL






| - 1 | DATE DRAWN: | 09/16/22 |
|-----|--------------|-----------------------------|
| | ATC JOB NO: | 13330269_G2 |
| | CUSTOMER ID: | MA1833 |
| | CUSTOMER #: | 15336751 |
| | | ATC JOB NO: CUSTOMER ID: |

GROUNDING DETAILS

SHEET NUMBER:

REVISION:

E-502

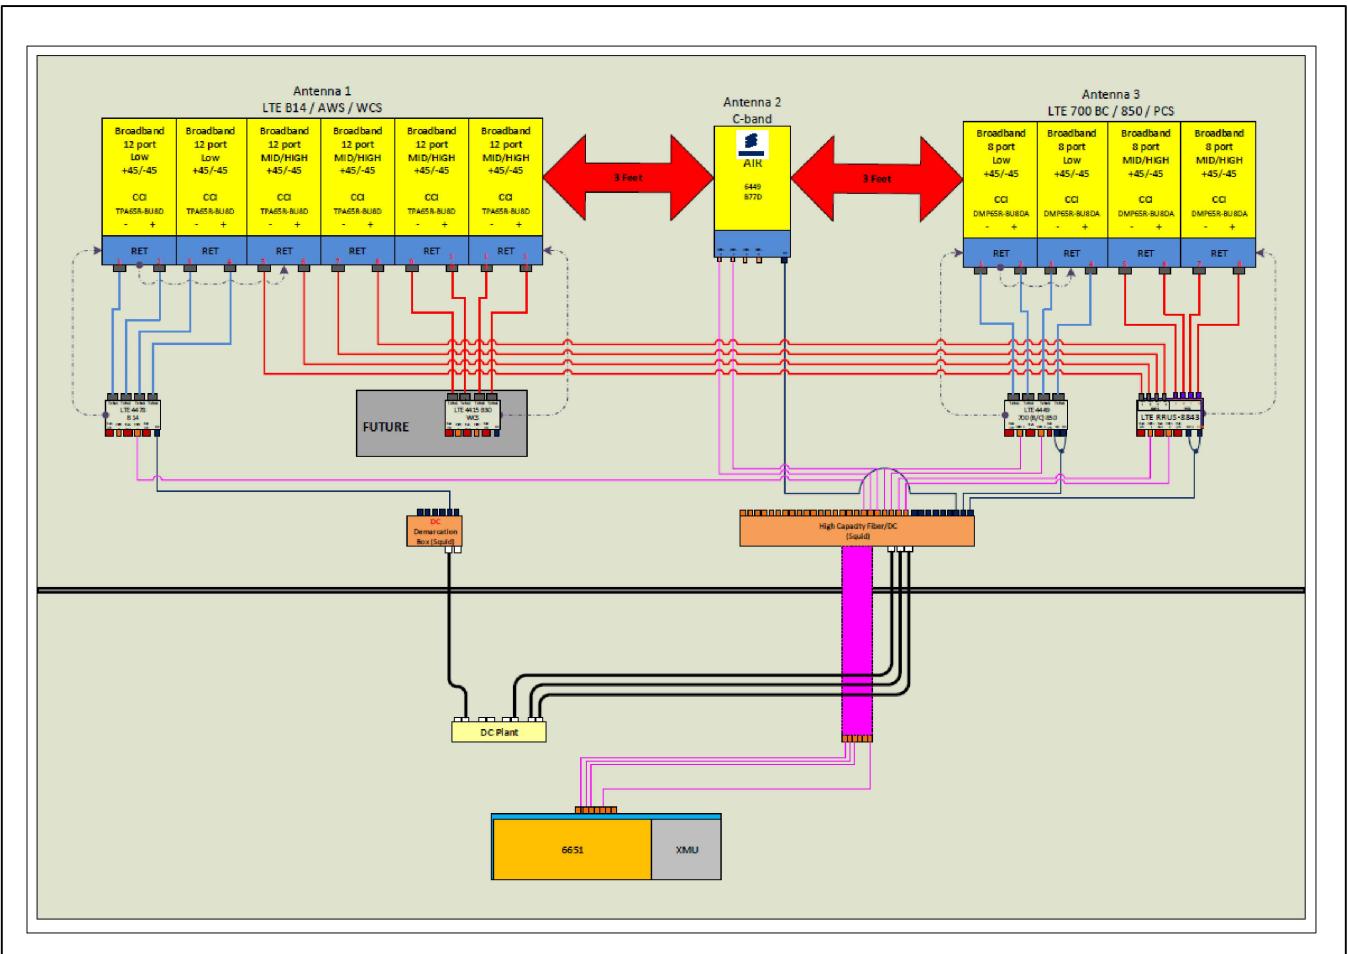



1033 WATERVLIET SHAKER RD ALBANY, NY 12205

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SEAL:






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| CUSTOMER #: | 15336751 | | |

SUPPLEMENTAL

SHEET NUMBER:

REVISION:

R-601

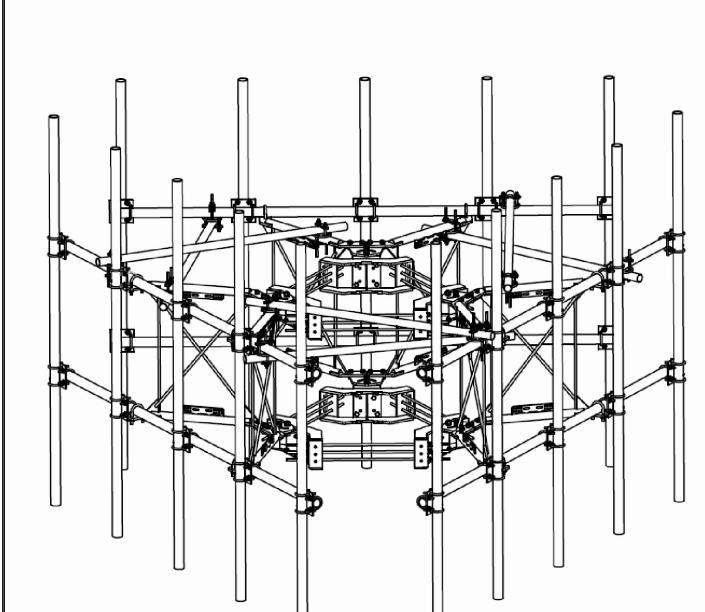

| | PARTS LIST | | | | | |
|------|------------|----------|--|-----------|-------------|---------|
| ITEM | QTY | PART NO. | PART DESCRIPTION | LENGTH | UNIT WT. | NET WT. |
| 1 | 6 | X-LWRM | RING MOUNT WELDMENT | | 68.81 | 412.85 |
| 2 | 6 | X-RMBP | RING MOUNT BENT PLATE CONNECTION | 15 1/2 in | 17.02 | 102.13 |
| 3 | 6 | X-VFAPL4 | VFA-HD PIVOT PLATE | 12 in | 15.88 | 95.30 |
| 4 | 6 | X-VFAW | SUPPORT ARM | | 71.41 | 428.44 |
| 5 | 30 | SCX2 | CROSSOVER PLATE | 7 in | 4.80 | 143.89 |
| 6 | 6 | P284 | 2-3/8" X 84" SCH 40 GALVANIZED PIPE | 84 in | 26.91 | 161.47 |
| 7 | 15 | P30120 | 2-7/8" x 120" (2-1/2" SCH. 40) GALVANIZED PIPE | 120 in | 58.07 | 870.99 |
| 8 | 6 | P30150 | 2-7/8" X 150" (2-1/2" SCH. 40) GALVANIZED PIPE | 150 in | 76.94 | 461.62 |
| 9 | 12 | X-127594 | FLAT DISK CLAMP PLATE 4" CENTERS (GALV.) | | 2.51 | 30.08 |
| 10 | 24 | X-100064 | CLAMP (4" V-CLAMP) GALVANIZED | | 0.92 | 22.12 |
| 11 | 12 | A34212 | 3/4" x 2-1/2" UNC HEX BOLT (A325) | 2 1/2 in | 0.48 | 5.75 |
| 12 | 18 | G34FW | 3/4" HDG USS FLATWASHER | | 0.06 | 1.06 |
| 13 | 12 | G34LW | 3/4" HDG LOCKWASHER | | 0.04 | 0.51 |
| 14 | 12 | G34NUT | 3/4" HDG HEAVY 2H HEX NUT | | 0.21 | 2.55 |
| 15 | 18 | G58R-48 | 5/8" x 48" THREADED ROD (HDG.) | | 4.18 | 75.27 |
| 16 | 12 | X-UB5300 | 5/8" X 3" X 5-1/4" X 2-1/2" U-BOLT (HDG.) | | 1.15 | 13.79 |
| 17 | 24 | A582112 | 5/8" x 2-1/2" HDG A325 HEX BOLT | 2 1/2 in | 0.33 | 8.02 |
| 18 | 24 | A582114 | 5/8" x 2-1/4" HDG A325 HEX BOLT | 2 1/4 in | 0.31 | 7.50 |
| 19 | 108 | G58LW | 5/8" HDG LOCKWASHER | | 0.03 | 2.82 |
| 20 | 108 | G58NUT | 5/8" HDG HEAVY 2H HEX NUT | | 0.13 | 14.03 |
| 21 | 120 | X-UB1300 | 1/2" X 3" X 5" X 2" GALV U-BOLT | | 0.74 | 88.64 |
| 22 | 24 | G12065 | 1/2" x 6-1/2" HDG HEX BOLT GR5 FULL THREAD | 5 1/2 in | 0.41 | 9.83 |
| 23 | 24 | G1204 | 1/2" x 4" HDG HEX BOLT GR5 FULL THREAD | 4 in | 0.27 | 6.48 |
| 24 | 288 | G12FW | 1/2" HDG USS FLATWASHER | 3/32 in | 0.03 | 9.82 |
| 25 | 288 | G12LW | 1/2" HDG LOCKWASHER | 1/8 in | 0.01 | 4.00 |
| 26 | 288 | G12NUT | 1/2" HDG HEAVY 2H HEX NUT | | 0.07 | 20.63 |
| | | | | | TOTAL WT. # | 2999.58 |

TOLERANCE NOTES

TOLERANCES ON DIMENSIONS, UNLESS OTHERWISE NOTED ARE: SAWED, SHEARED AND GAS CUT EDGES (± 0.030°) - NO CONING OF HOLES LASER CUT EDGES AND HOLES (± 0.010°) - NO CONING OF HOLES BENDS ARE ± 1/2 DEGREE ALL OTHER MACHINING (± 0.030") ALL OTHER ASSEMBLY (± 0.060")

AND MONOPOLE ATTACHMENT HARDWARE WITH FIVE MOUNTING PIPES DRAWN BY ENG. APPROVAL CEK 10/26/2018 PROPRIETAT: NOTE:

THE DATA AND TECHNIQUES CONTAINED IN THIS DRAWING ARE PROPRIETATY INFORMATION OF VALMONT
INDUSTRIES AND CONSIDERED A TRADE SECRET. ANY USE OR DISCLOSURE WITHOUT THE CONSENT OF DRAWING USAGE CHECKED BY

CUSTOMER

81 02

THREE SECTORS HEAVY WLL FRAME

BMC 10/29/2018

Locations: New York, NY Atlanta, GA Los Angeles, CA Plymouth, IN Salem, OR Dallas, TX

VFA12-M3-WLL DWG. NO. VFA12-M3-WLL

AMERICAN TOWER® ATC TOWER SERVICES, LLC

INFINIGY8 **ENGINEERING, PLLC**

1033 WATERVLIET SHAKER RD ALBANY, NY 12205

| REV. DESCRIPTION | | BY | DATE |
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| <u> </u> | PRELIM | DB_ | 12/30/20 |
| <u></u> | PRELIM | <u>SP</u> | 08/15/22 |
| <u> </u> | PRELIM | RCD | 08/16/22 |
| ₾_ | PRELIM | DGD | 09/14/22 |
| △_ | FOR CONSTRUCTION | DGD | 09/16/22 |

ATC SITE NUMBER:

91567

ATC SITE NAME:

RJ COBB

AT&T MOBILITY SITE NAME:

BELLINGHAM MAPLE STREET SITE ADDRESS:

236 MAPLE STREET BELLINGHAM, MA 02019-3019





| | DATE DRAWN: | 09/16/22 |
|---|--------------|-------------|
| П | ATC JOB NO: | 13330269_G2 |
| П | CUSTOMER ID: | MA1833 |
| П | CUSTOMER #: | 15336751 |
| | | |


SUPPLEMENTAL

SHEET NUMBER:

REVISION:

R-602

SITE PRO 1 VFA12-M3-WLL SECTOR FRAME DETAIL SCALE: N.T.S.

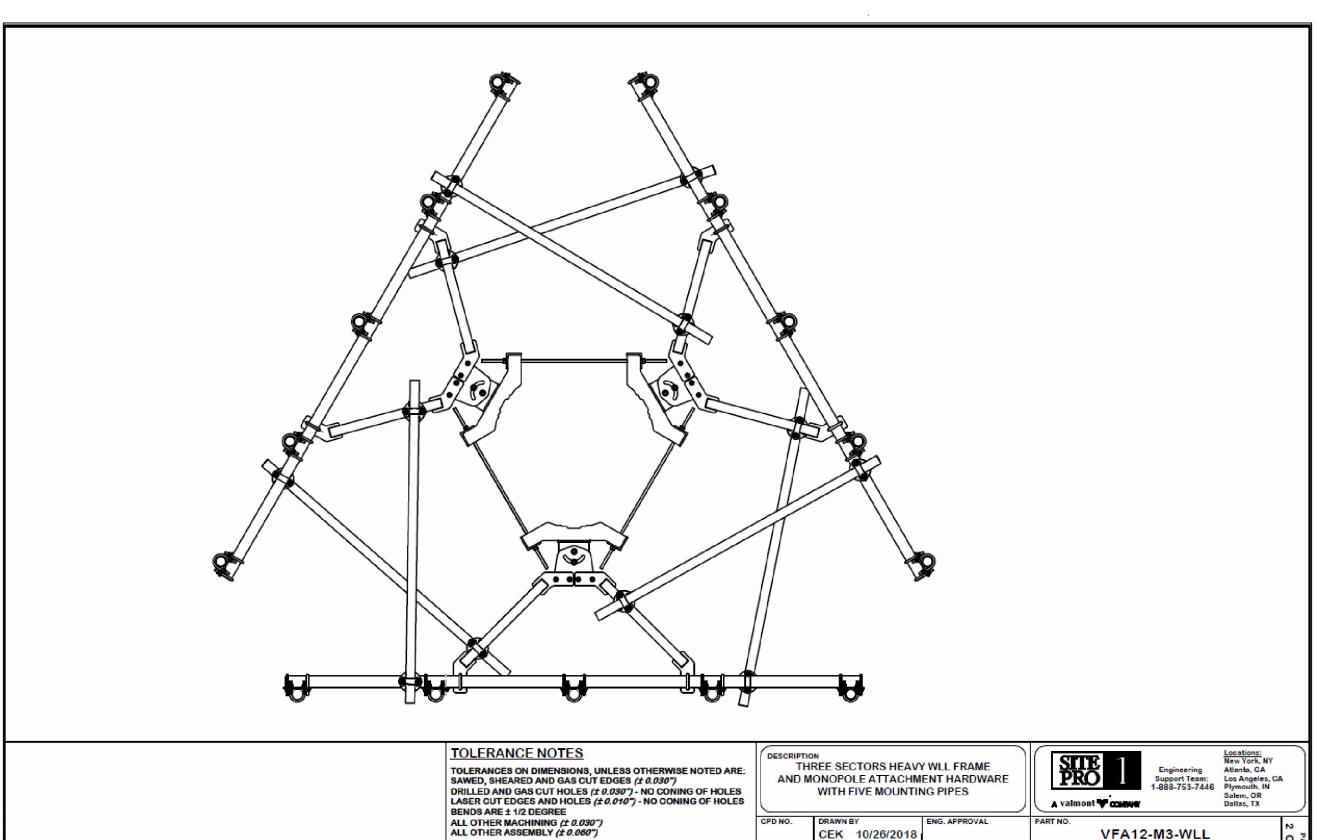



1033 WATERVLIET SHAKER RD ALBANY, NY 12205

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| \wedge | FOR CONSTRUCTION | DGD | 09/16/22 |

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FOR REFERENCE **ONLY**



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| П | CUSTOMER #: | 15336751 |
| | | |

SUPPLEMENTAL

SHEET NUMBER:

REVISION:

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R-603

SITE PRO 1 VFA12-M3-WLL SECTOR FRAME DETAIL SCALE: N.T.S.

PROPRIÉTARY NOTÉ:
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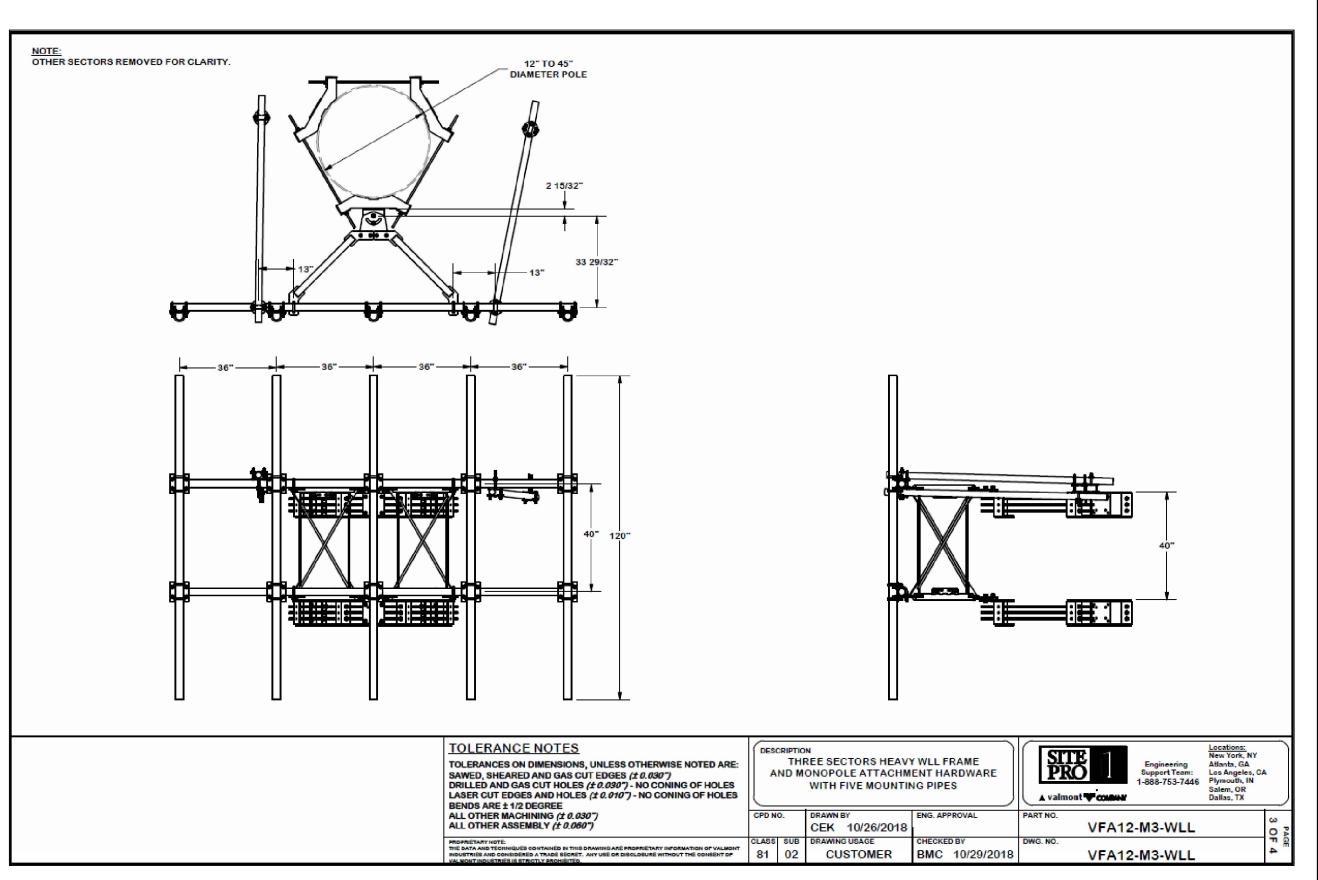
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BMC 10/29/2018

VFA12-M3-WLL

CLASS SUB 81 02





1033 WATERVLIET SHAKER RD ALBANY, NY 12205

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SITE ADDRESS: 236 MAPLE STREET BELLINGHAM. MA 02019-3019






13330269_G2 ATC JOB NO: CUSTOMER ID: MA1833 CUSTOMER #: 15336751

SUPPLEMENTAL

SHEET NUMBER:

REVISION:

R-604

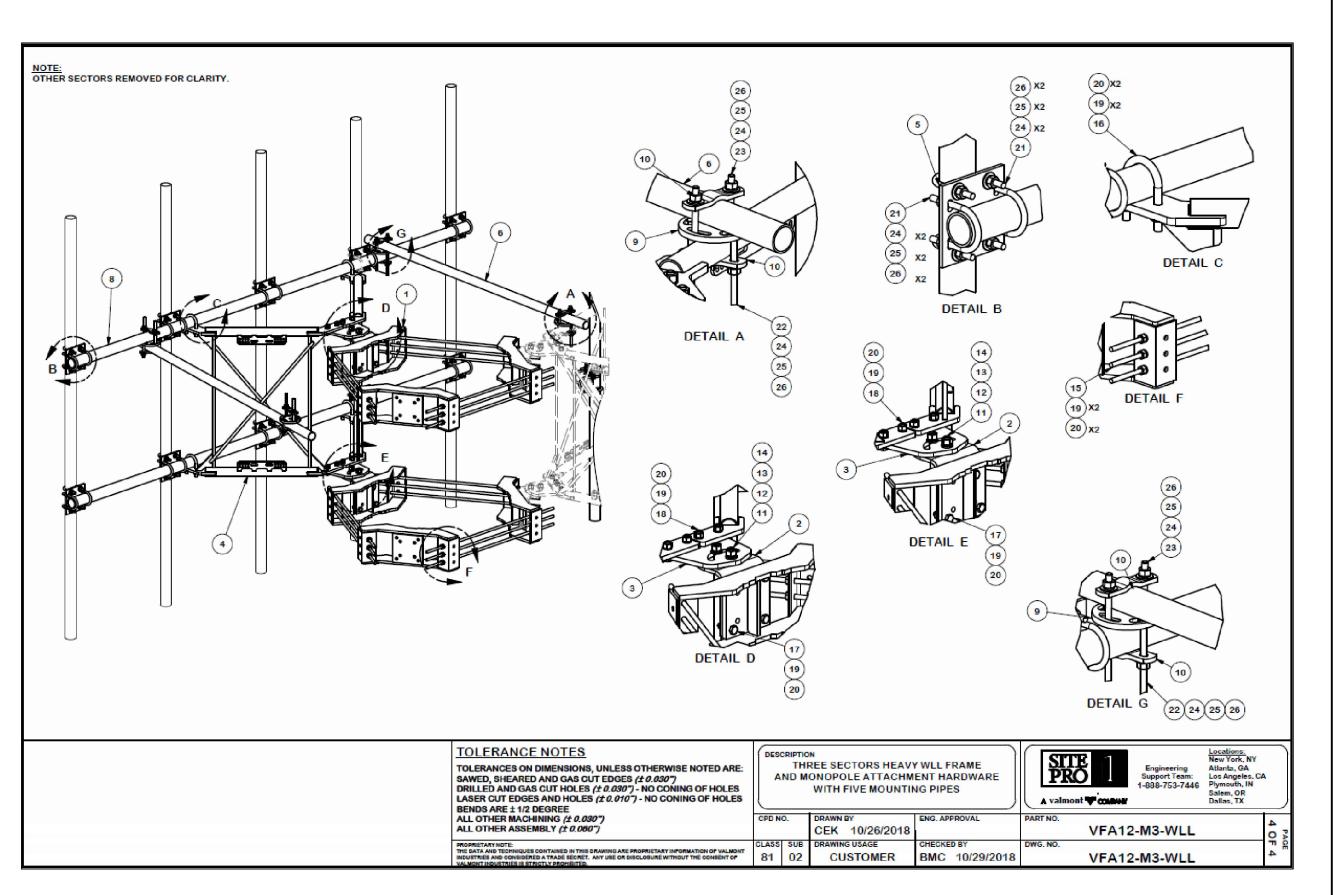



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ALBANY, NY 12205

| PTION BY | DATE |
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| LIM DB | 12/30/20 |
| LIM SP | 08/15/22 |
| LIM RCD | 08/16/22 |
| LIM DGD | 09/14/22 |
| TRUCTION DGD | 09/16/22 |
| | LIM DB LIM SP LIM RCD LIM DGD |

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SITE ADDRESS: 236 MAPLE STREET BELLINGHAM, MA 02019-3019





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| ATC JOB NO: | 13330269_G2 |
| CUSTOMER ID: | MA1833 |
| CUSTOMER #: | 15336751 |
| | |

SUPPLEMENTAL

SHEET NUMBER:

REVISION:

R-605

AMERICAN TOWER®

CORPORATION



Antenna Mount Analysis Report

ATC Site Name : RJ COBB **ATC Site Number**

Engineering Number : 13330269_C8_01 ETS, PLLC Job Number : 21090471.STR.5368

: 135 ft Mount Elevation

: AT&T Mobility Carrier **Carrier Site Name** : MRCTB048320 Carrier Site Number : MA1833S

: 236 Maple Street Site Location

Bellingham, MA 02019-3019

 $Engineered \ Tower Solutions, PLLC-3227 \ Wellington \ Court, Raielgh, NC 27615-919.782.2710 \ Office-www.engineered tower solutions.com$

42.102300,-71.447100

County : Norfolk

: March 25, 2021 Date

Max Usage : 78%

Result : Replacement - Pass

Prepared By: Douglas H. Kosiba, PE Structural Engineering Lead



Eng. Number 13330269_C8_01

The purpose of this report is to summarize results of the antenna mount analysis performed for AT&T Mobility at 135 ft.

Supporting Documents

| Spec. Sheet | Site Pro 1 VFA12-M3-WLL , dated October 29, 2018 |
|-------------|--|
| RFDS | RFDS (15336751) dated March 2, 2021 |

Analysis

This antenna mount was analyzed using RISA-3D v17.0.4 analysis software


| Basic Wind Speed: | 121 mph (3-Second Gust) |
|-------------------------------|--|
| Basic Wind Speed w/ Ice: | 50 mph (3-Second Gust) w/ 1" radial ice concurrent |
| Codes: | ANSI/TIA-222-H |
| Structure Class: | II |
| Exposure Category: | В |
| Topographic Factor Procedure: | Method 2 |
| Feature: | Flat |
| Crest Height (H): | 0 ft |
| Crest Length (L): | 0 ft |
| Spectral Response: | Ss = 0.212, S ₁ = 0.059 |
| Site Class: | D - Default |
| Live Loads: | Lm = 500 lbs. Lv = 250 lbs |

The below mount shall be installed to support the customer's proposed loading configuration. Based on the analysis results, the proposed mount meets the requirements, per the applicable codes listed above, and can support the equipment as described in this report.

Site Pro 1 VFA12-M3-WLL

If you have any questions or require additional information, please contact American Tower via email at ENG.Outsource@americantower.com. Please include the American Tower site name, site number, and engineering number in the subject line for any questions.

Engineered Tower Solutions, PLLC - 3227 Wellington Court, Raikigh, NC 27615 - 919.782.2710 Office - www.engineered towersolutions.com

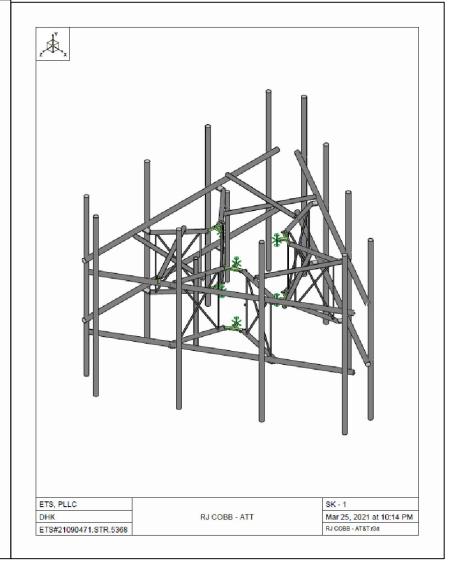



INFINIGY8 **ENGINEERING, PLLC**

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| △_ | FOR CONSTRUCTION | DGD | 09/16/22 |

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236 MAPLE STREET BELLINGHAM. MA 02019-3019





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| | |


SUPPLEMENTAL


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REVISION:

R-606

MOUNT ANALYSIS



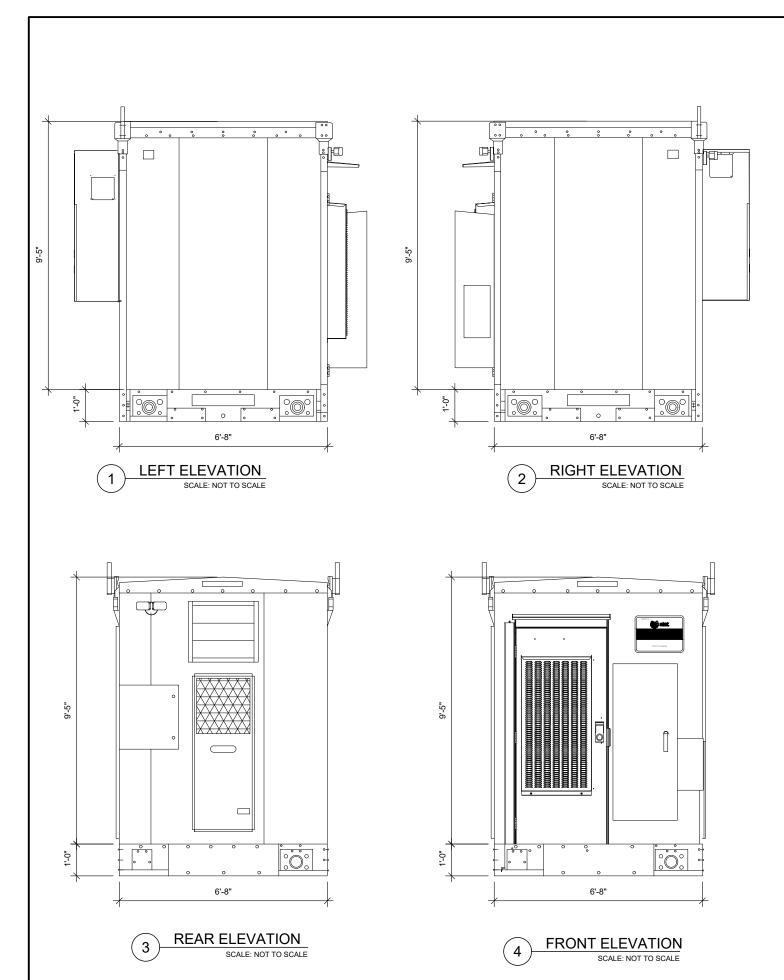

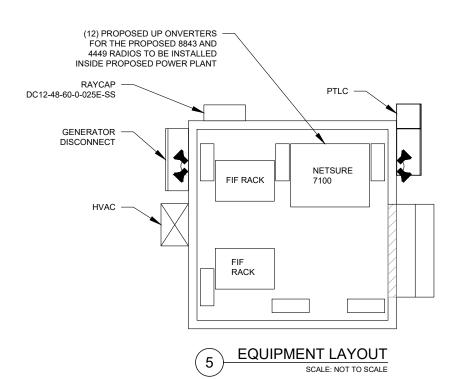

1033 WATERVLIET SHAKER RD ALBANY, NY 12205

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SITE ADDRESS: 236 MAPLE STREET BELLINGHAM, MA 02019-3019

SEAL:






| DATE DRAWN: | 09/16/22 |
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| | |

SUPPLEMENTAL

SHEET NUMBER:

REVISION:

R-607

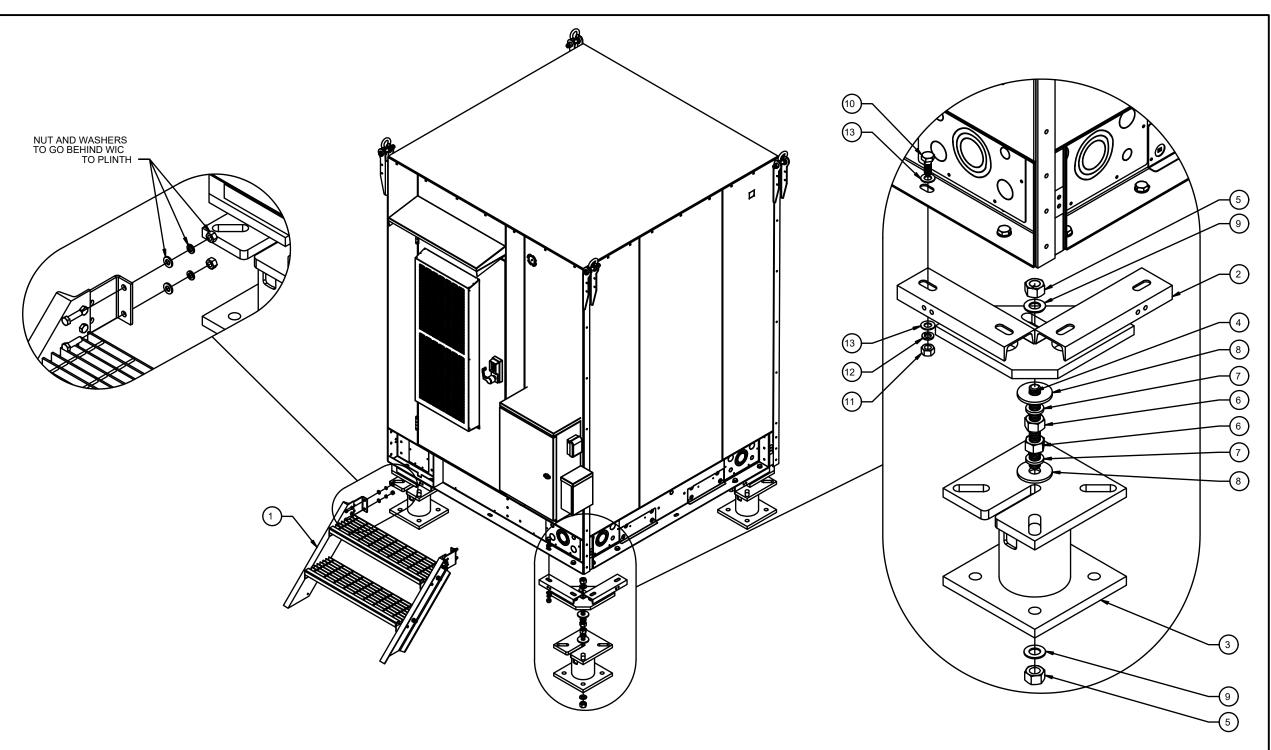

| NOT | EC. |
|-----|-----|

- 1. WIC DETAIL BASED ON DRAWINGS BY VERTIV
- ANCHOR WIC OR PLINTH W/ 1/2" HILTI TZ ANCHORS, EMBEDDED 3-3/4" WITH HILTI HY200 EPOXY ADHESIVE COMPOUND.
- GALVANIZED P1000 TO BE UTILIZED AT WIC FOR DC12, FMB & RRH'S. CAP ENDS & INSTALL PER MANUFACTURER RECOMMENDATIONS.

| ITEM NO. | QTY. | PART NUMBER | DESCRIPTION | WEIGHT |
|-------------|------|----------------|---|--------|
| 1 | 1 | 1003-0000-0016 | WIC 2-STEP STAIRS KIT, 45 DEGREE | 102.9 |
| 2 | 4 | W-000-771 | ATT WIC HELICAL ADAPTER WELDMENT | 44.9 |
| 3 | 4 | W-000-847 | 6" X 11" EXTENSION WELDMENT | 81.5 |
| 4 | 4 | 002-0AT-H000 | ROD, THREADED, 1.00"-8 X 9.00" LG, ASTM A193 B7, GALV | 1.60 |
| 5 | 8 | 002-0NG-0000 | NUT, HX, ANCO LOCK, 1.00-8UNC, GR 2H, GALV | 0.43 |
| 6 | 8 | 002-0NG-0008 | NUT, HX, 1.00"-8UNC, GR 2H, GALV | 0.42 |
| 7 | 8 | 002-0LW-G008 | WASHER, SPLIT LOCK, 1.00", GALV | 0.09 |
| 8 | 8 | 002-0FW-G024 | WASHER, FLAT, 1.063 ID, 3.25 OD, GALV | 0.07 |
| 9 | 8 | 002-0FW-G009 | WASHER, FLAT, 1.00", F436, GALV | 0.08 |
| 10 | 16 | 002-0BG-0033 | BOLT, HX HD, .625-11UNC X 1.75" LG, ASTM A325, GALV | 0.03 |
| 11 | 16 | 002-0NG-0011 | NUT, HX, .625-11UNC, GR DH, GALV | 0.12 |
| 12 | 16 | 002-0LW-G004 | WASHER, SPLIT LOCK, .625 INCH, GALV | 0.03 |
| 13 | 32 | 002-0FW-G004 | WASHER, FLAT, .625", ASTM F436, GALV | 0.03 |



1033 WATERVLIET SHAKER RD ALBANY, NY 12205

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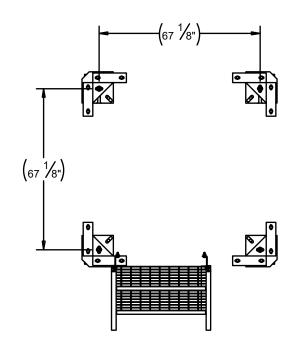
| DATE DRAWN: | 09/16/22 |
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| ATC JOB NO: | 13330269_G2 |
| CUSTOMER ID: | MA1833 |
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SUPPLEMENTAL


SHEET NUMBER:

REVISION:

R-608






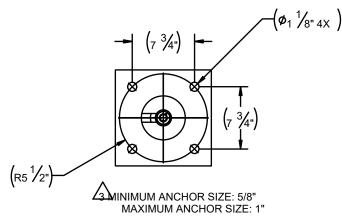




NOTES:

- 1. WIC DETAIL BASED ON DRAWINGS BY VERTIV
- ANCHOR WIC OR PLINTH W/ 1/2" HILTI TZ ANCHORS, EMBEDDED 3-3/4" WITH HILTI HY200 EPOXY ADHESIVE COMPOUND.
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| 5 | 8 | 002-0NG-0000 | NUT, HX, ANCO LOCK, 1.00-8UNC, GR 2H, GALV | 0.43 |
| 6 | 8 | 002-0NG-0008 | NUT, HX, 1.00"-8UNC, GR 2H, GALV | 0.42 |
| 7 | 8 | 002-0LW-G008 | WASHER, SPLIT LOCK, 1.00", GALV | 0.09 |
| 8 | 8 | 002-0FW-G024 | WASHER, FLAT, 1.063 ID, 3.25 OD, GALV | 0.07 |
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| 13 | 32 | 002-0FW-G004 | WASHER, FLAT, .625", ASTM F436, GALV | 0.03 |

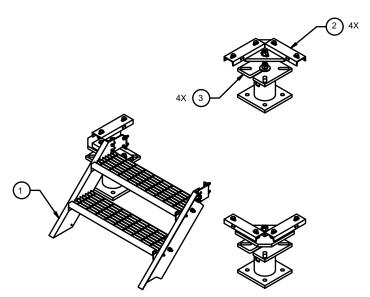
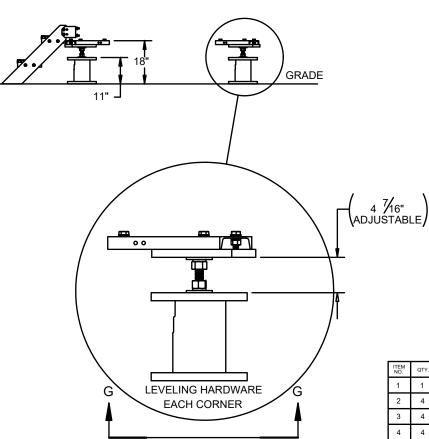
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SUPPLEMENTAL

SHEET NUMBER:

R-609

